



600 Kansas City St
Rapid City, SD 57701

(605) 343-6102
www.teamtsp.com

Addendum No. 2

Issued:	September 15, 2023
Bids Due:	September 21, 2023
Project Name:	Renovate General's Quarters – Camp Rapid, B250
TSP Project No:	03221580
Owner Project No:	CFMO# 466501

The following changes or modifications are to be incorporated into and become a part of the Contract Documents. The Bidder shall note receipt and make acknowledgement of this Addendum on the Bid Proposal, incorporating these provisions in the bid.

PRODUCT APPROVALS:

The following manufacturers and products have been approved for bidding. Final acceptance is contingent upon receipt and approval of final shop drawings/submittals. Manufacturers shall conform to all warranties, performances, sizes, materials, etc. as the item specified. The burden of proof of the merit of the proposed substitution is upon the proposer.

<u>SECTION #</u>	<u>ITEM DESCRIPTION</u>	<u>MANUFACTURER</u>
22 11 19	Point of Use Mixing Valve	Powers Controls
22 33 00	Water Heaters	State Industries
22 40 00	Faucets	American Standard

DRAWINGS:


ITEM NO 1:	Revised Keynote 15 which appears on sheets S-101, S-102, S-103, & S-104 to read as follows "DEMOLISH EXISTING CHIMNEY. INFILL EXISTING OPENINGS IN FLOOR FRAMING AND ROOF FRAMING WITH BLOCKING AND DECKING (MATCH EXISTING) AS REQUIRED."
ITEM NO 2:	<u>AD101, Lower Level Demolition Plan:</u> Demo'd window infill where electricity enters the building. Fixed the keynote number for wall removal.
ITEM NO 3:	<u>AP101, First Level Floor Plan:</u> Removed the detail for the false chimney.
ITEM NO 4:	<u>AP102, Lower Level Floor Plan:</u> Indicated new infill where the wood window infill was.
ITEM NO 5:	<u>AF101, Schedules:</u> Changed door type B to a flat front.
ITEM NO 6:	<u>ED101, Electrical Demolition Plan:</u> Demo'd the existing exterior receptacle on the plan east wall.
ITEM NO 7:	<u>EP101, Electrical Power Plans:</u> Provided a new exterior receptacle on the plan east wall. Receptacle to be mounted where wall is to be patched at the exterior.

ATTACHMENTS:


- Drawings AD101, AP101, AP102, AF101, ED101, EP101

END OF ADDENDUM

LISTED DRAWINGS SCALE(S) UNLESS REDUCED FROM ORIGINAL 22 x 34 FORMAT

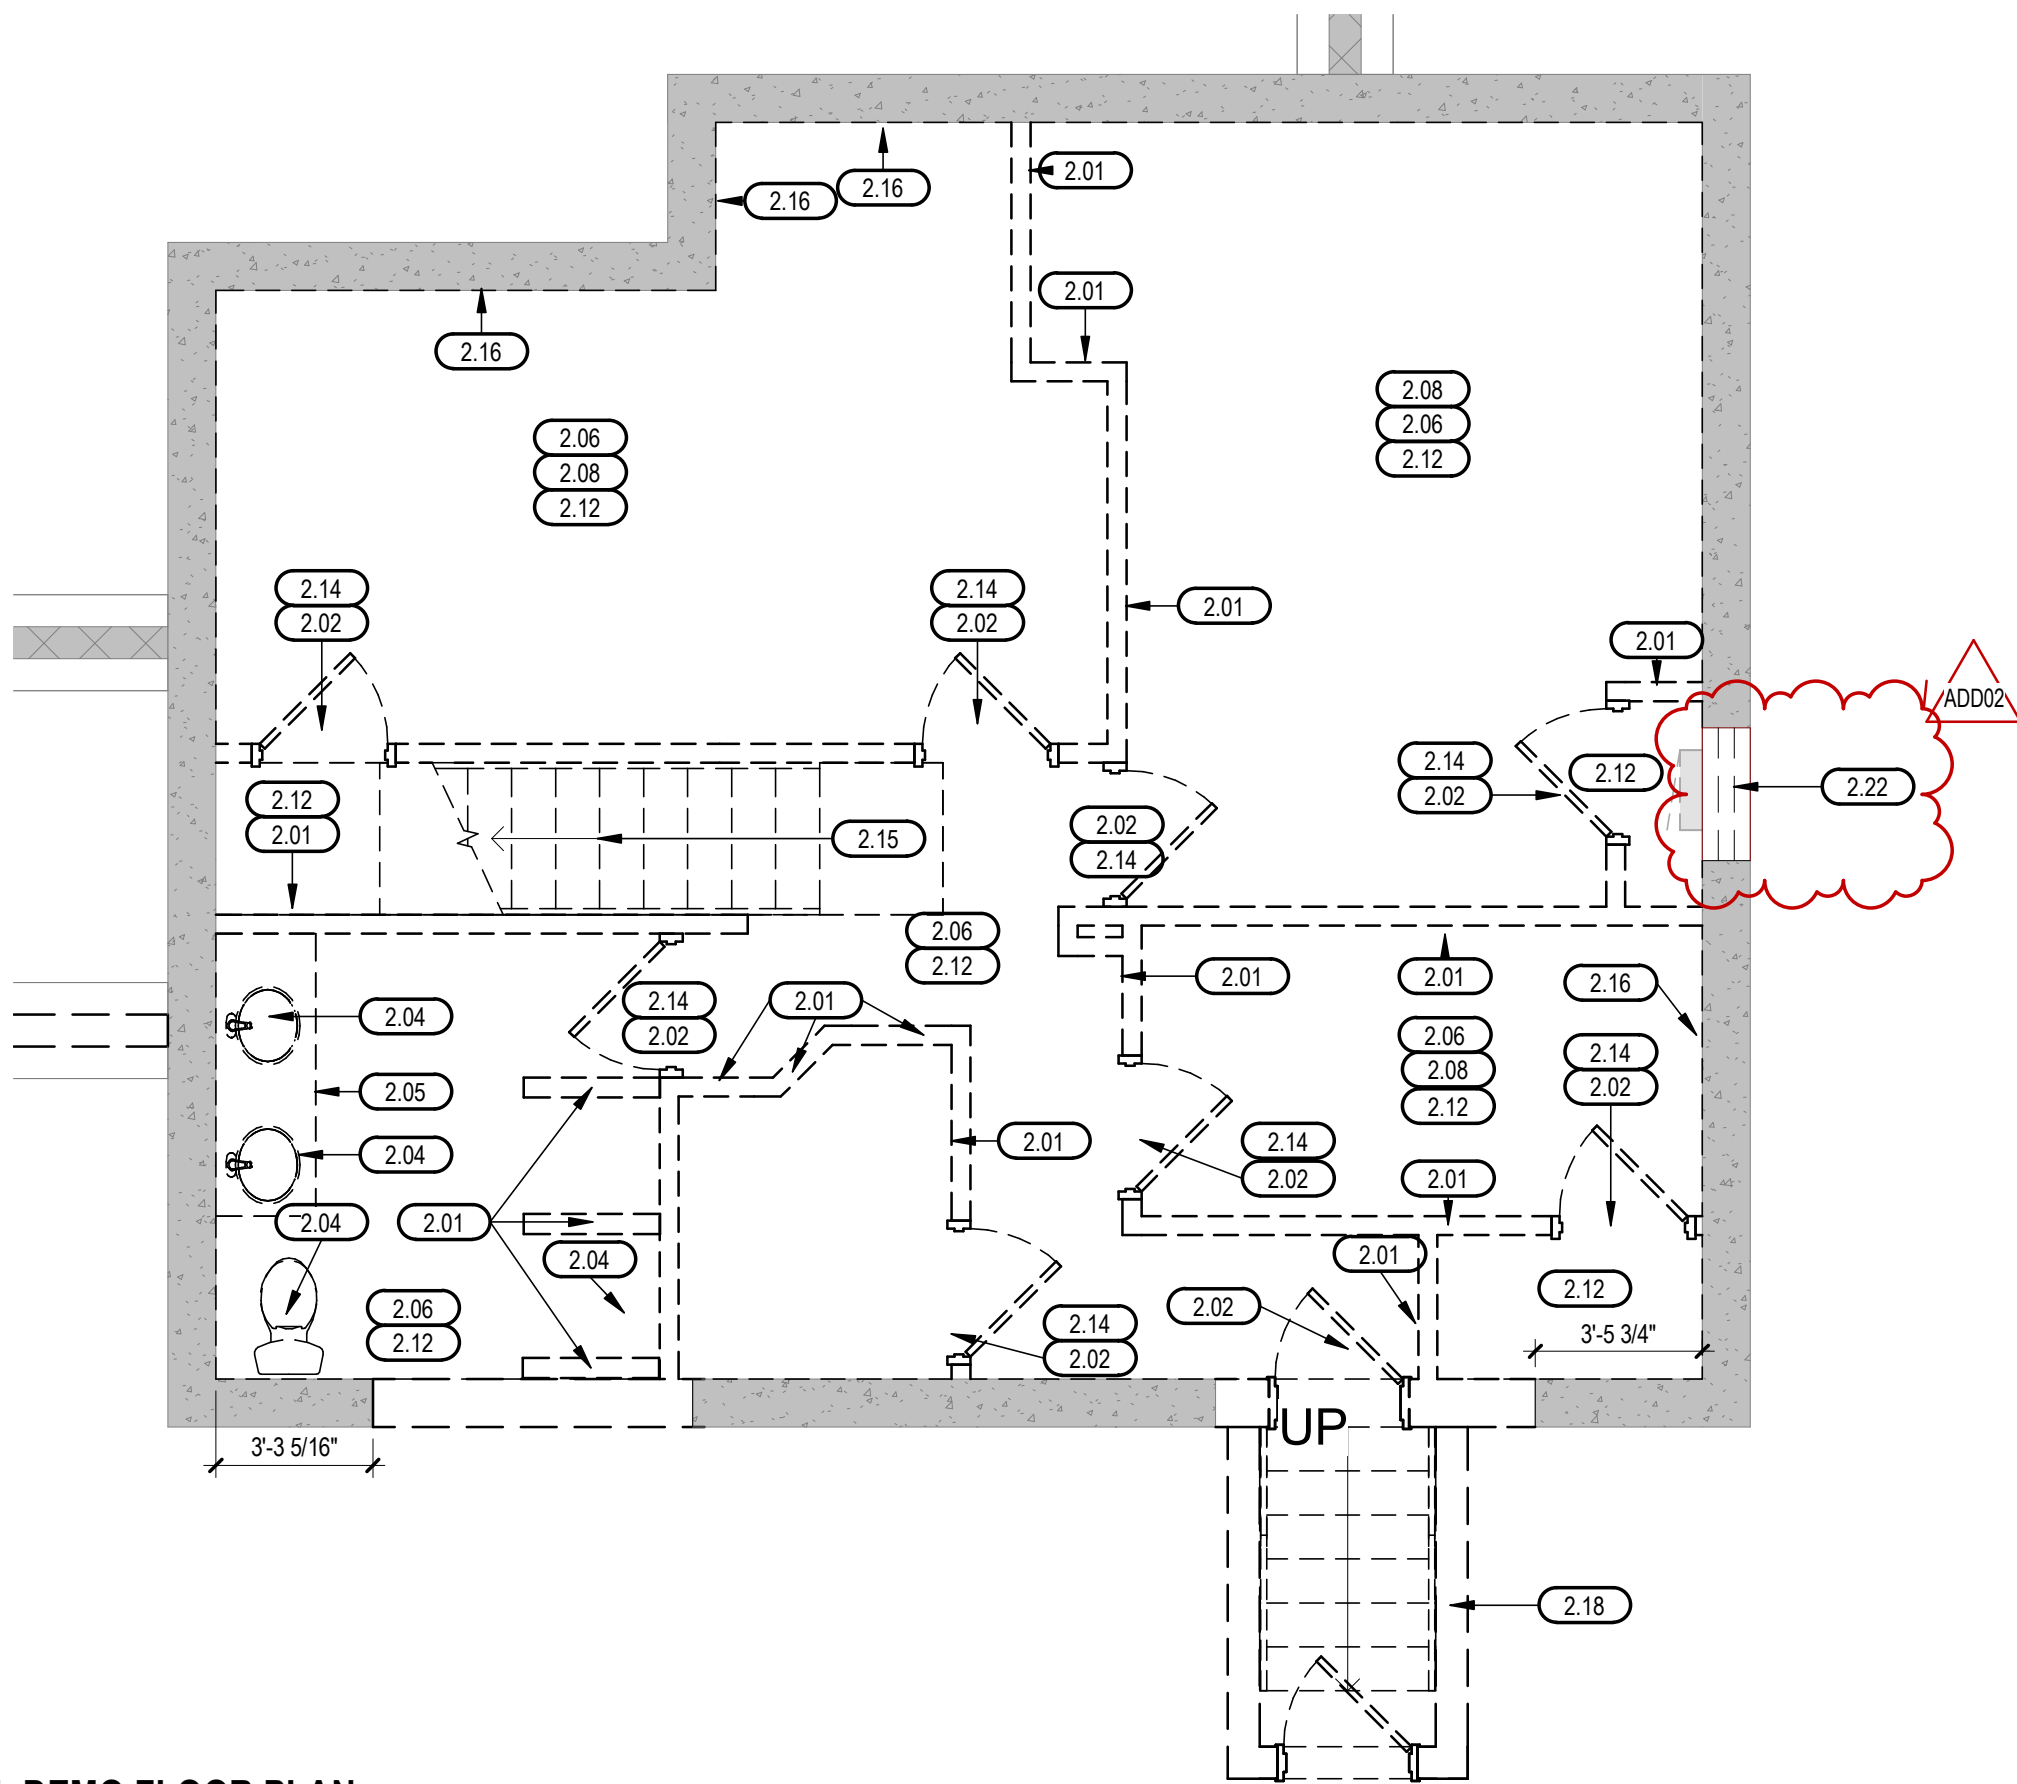

B1 LOWER LEVEL DEMO FLOOR PLAN
SCALE: 1/4" = 1'-0"

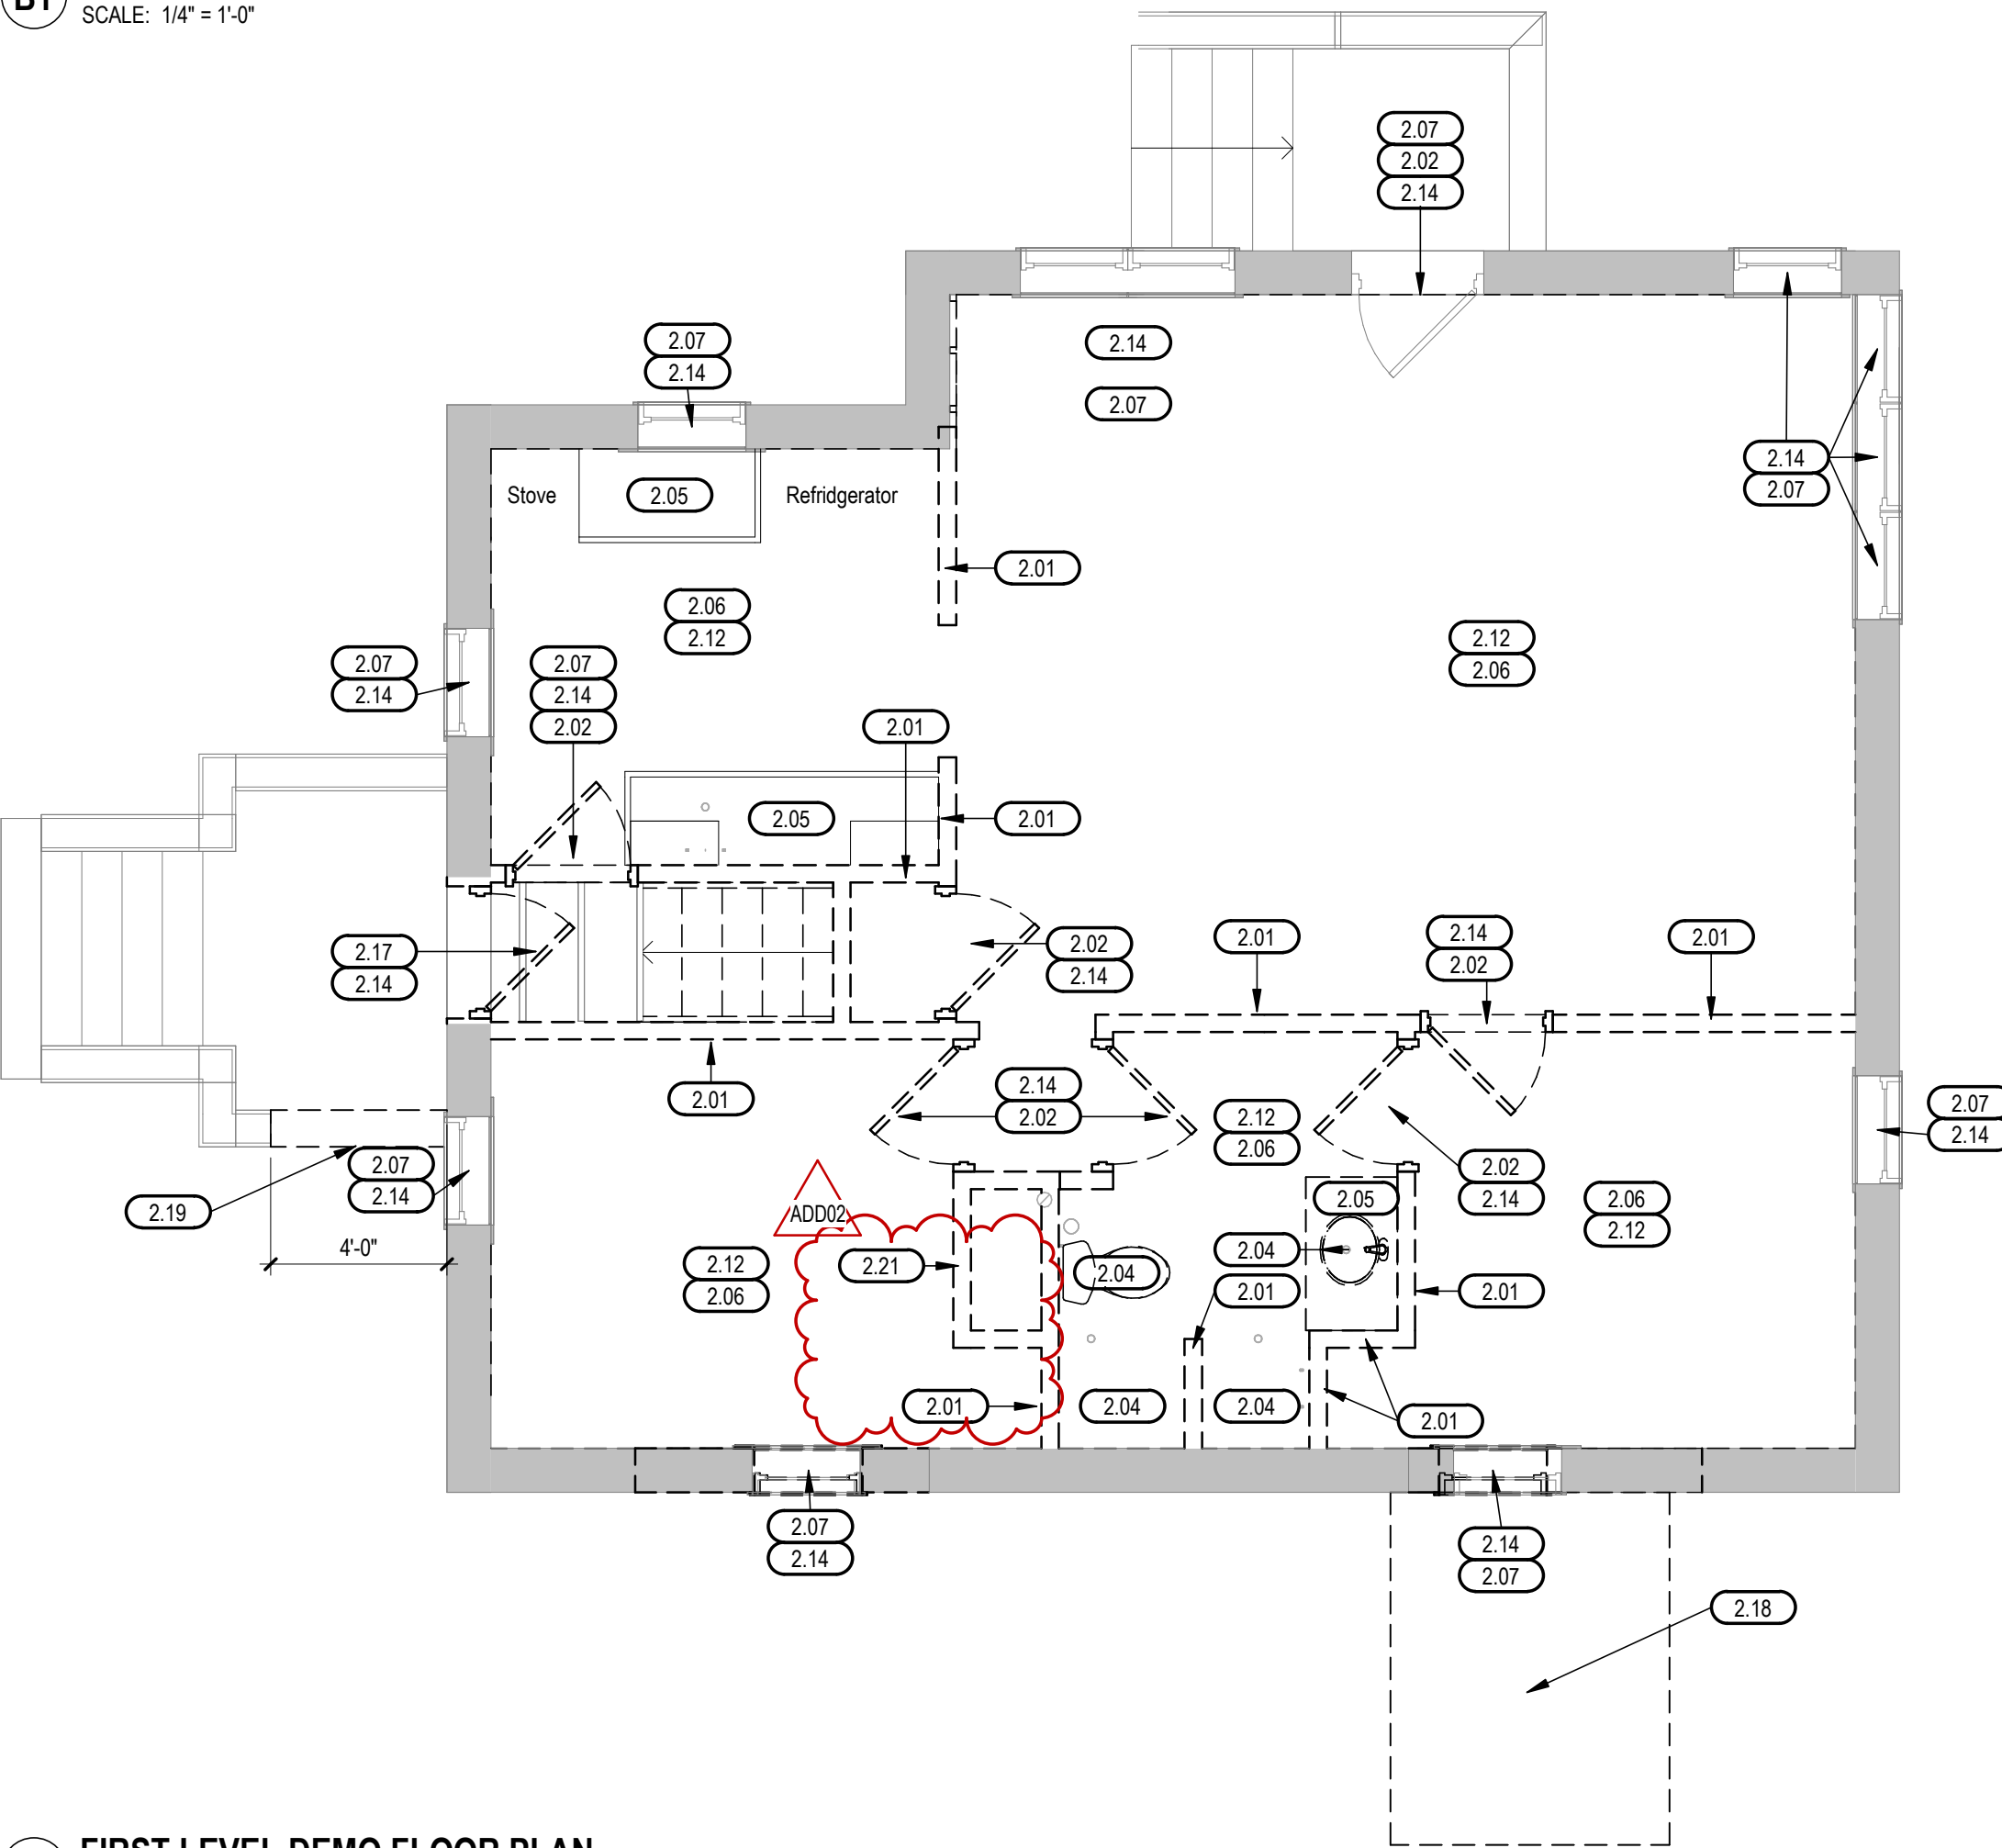

A1 FIRST LEVEL DEMO FLOOR PLAN
SCALE: 1/4" = 1'-0"

DEMOLITION PLAN GENERAL NOTES

- A. GENERAL CONTRACTOR IS RESPONSIBLE FOR ALL DEMOLITION NECESSARY TO ALLOW FOR COMPLETION OF WORK AS DESCRIBED IN THE CONSTRUCTION DOCUMENTS - DEMOLITION OPERATIONS SHALL INCLUDE, BUT ARE NOT LIMITED TO THE ITEMS DESCRIBED BY KEYNOTES HEREIN.
- B. ALL SURFACES DAMAGED DURING DEMOLITION SHALL BE REPAIRED FOR APPLICATION OF NEW FINISHES OR PATCHED TO MATCH EXISTING. INDEPENDENT TRADES ARE RESPONSIBLE FOR THEIR RESPECTIVE CUT AND PATCH. REFER TO SPECIFICATIONS.
- C. CONTRACTOR SHALL FIELD VERIFY ALL EXISTING CONDITIONS AND DIMENSIONS WHICH ARE TO MATCH EXISTING CONSTRUCTION. CONTACT A/E WITH DISCREPANCIES.
- D. COORDINATE DEMOLITION WITH OWNER'S SCHEDULE FOR OCCUPANCY.
- E. TEMPORARY PARTITIONS SHOULD BE SECURE AND WATERTIGHT.
- F. WHERE EXISTING DOORS ARE SHOWN TO BE REMOVED, ASSOCIATED FRAMES ARE TO BE REMOVED AS WELL.
- G. REFER TO STRUCTURAL SHEET S-101 FOR DEMO OF STRUCTURAL ITEMS.
- E. REMOVE INSULATION IN ATTIC.
- F. REMOVE ENTIRETY OF LOWER LEVEL FLOOR SLAB FOR PLUMBING AND STRUCTURAL WORK. COORDINATE/PHASE AS REQUIRED WITH SHORING REQUIREMENTS.

DEMOLITION PLAN LEGEND

- 2-###** REFERENCE KEYNOTE TAG
- CONSTRUCTION LIMITS
- AREAS TO RECEIVE NO WORK
- EXISTING WALL TO REMAIN
- - - EXISTING WALL REMOVED
- EXISTING DOOR TO REMAIN
- - - EXISTING DOOR AND FRAME REMOVED
- EXISTING WINDOW TO REMAIN
- - - EXISTING WINDOW REMOVED
- EXISTING CASEWORK TO REMAIN
- - - EXISTING CASEWORK REMOVED
- EXISTING WATER CLOSET TO REMAIN
- EXISTING WATER CLOSET REMOVED
- EXISTING URINAL TO REMAIN
- EXISTING URINAL REMOVED
- EXISTING LAVATORY TO REMAIN
- EXISTING LAVATORY REMOVED

REFERENCE KEYNOTES

2.01	DEMO EXISTING WALL CONSTRUCTION.
2.02	DEMO EXISTING DOOR, FRAME, AND HARDWARE.
2.04	DEMO EXISTING PLUMBING FIXTURE. REFER TO MECHANICAL DRAWINGS FOR ADDITIONAL INFORMATION.
2.05	DEMO ALL CASEWORK, COUNTERTOP, AND MOUNTING STANDARDS.
2.06	DEMO EXISTING FLOOR FINISH, ADHESIVE, AND WALL BASE AND PREP TO RECEIVE NEW FINISH.
2.07	DEMO EXISTING BLINDS AND PREP WINDOWS FOR NEW HBT.
2.08	DEMO EXISTING CEILING IN ITS ENTIRETY. REFERENCE RCP FOR NEW CEILING REQUIREMENTS.
2.12	DEMO EXISTING TRIMBASE AROUND PERIMETER AND PREP FOR NEW.
2.14	REMOVE ALL TRIM AROUND DOORS/WINDOWS AND PREP FOR NEW TRIM TO BE INSTALLED.
2.15	DEMO EXISTING STAIR ASSEMBLY.
2.16	DEMO WALL PANELING - GYP WALL TO MATCH.
2.17	REMOVE EXTERIOR DOOR AND DEMO WALL AS REQUIRED FOR INSTALLATION OF NEW DOOR AND HEADER.
2.18	REMOVE STAIR, STAIRWELL, INCLUDING ROOF, AND DOORS. RETAIN BRICKS FOR REUSE.
2.19	DEMO AS REQUIRED FOR INSTALLATION OF NEW RAMP LANDING AND CONNECTION. REFER TO STRUCTURAL.
2.21	REMOVE CHIMNEY IN ITS ENTIRETY, INCLUDING ABOVE THE ROOF. NEW FAKE CHIMNEY TO BE INSTALLED AT THE ROOF.
2.22	REMOVE EXISTING WOODEN INFILL PANEL AND ELECTRICAL AS REQUIRED.




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PROJECT TITLE



**SOUTH DAKOTA
DEPARTMENT OF THE
MILITARY
RENOVATE GENERALS
QUARTERS BUILDING
250**

RC CAMP RAPID

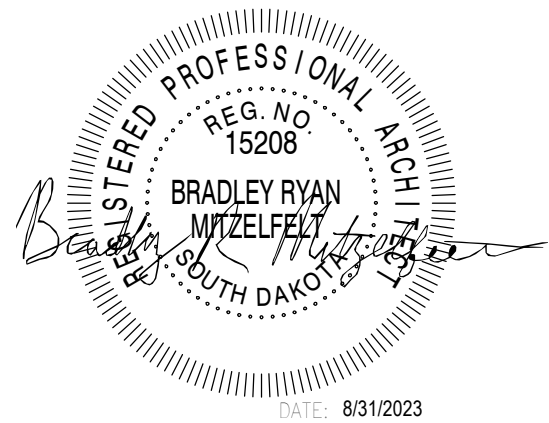ISSUES

ADD02 ISSUE	09/15/2023 DATE	ADDENDUM 02 DESCRIPTION
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ISSUE DATE 08/31/2023	DRAWN BY BRM
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PROJECT # 03221580	CHECKED BY BRM
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SHEET TITLE

**DEMOLITION FLOOR
PLANS**

SHEET NUMBER

AD101

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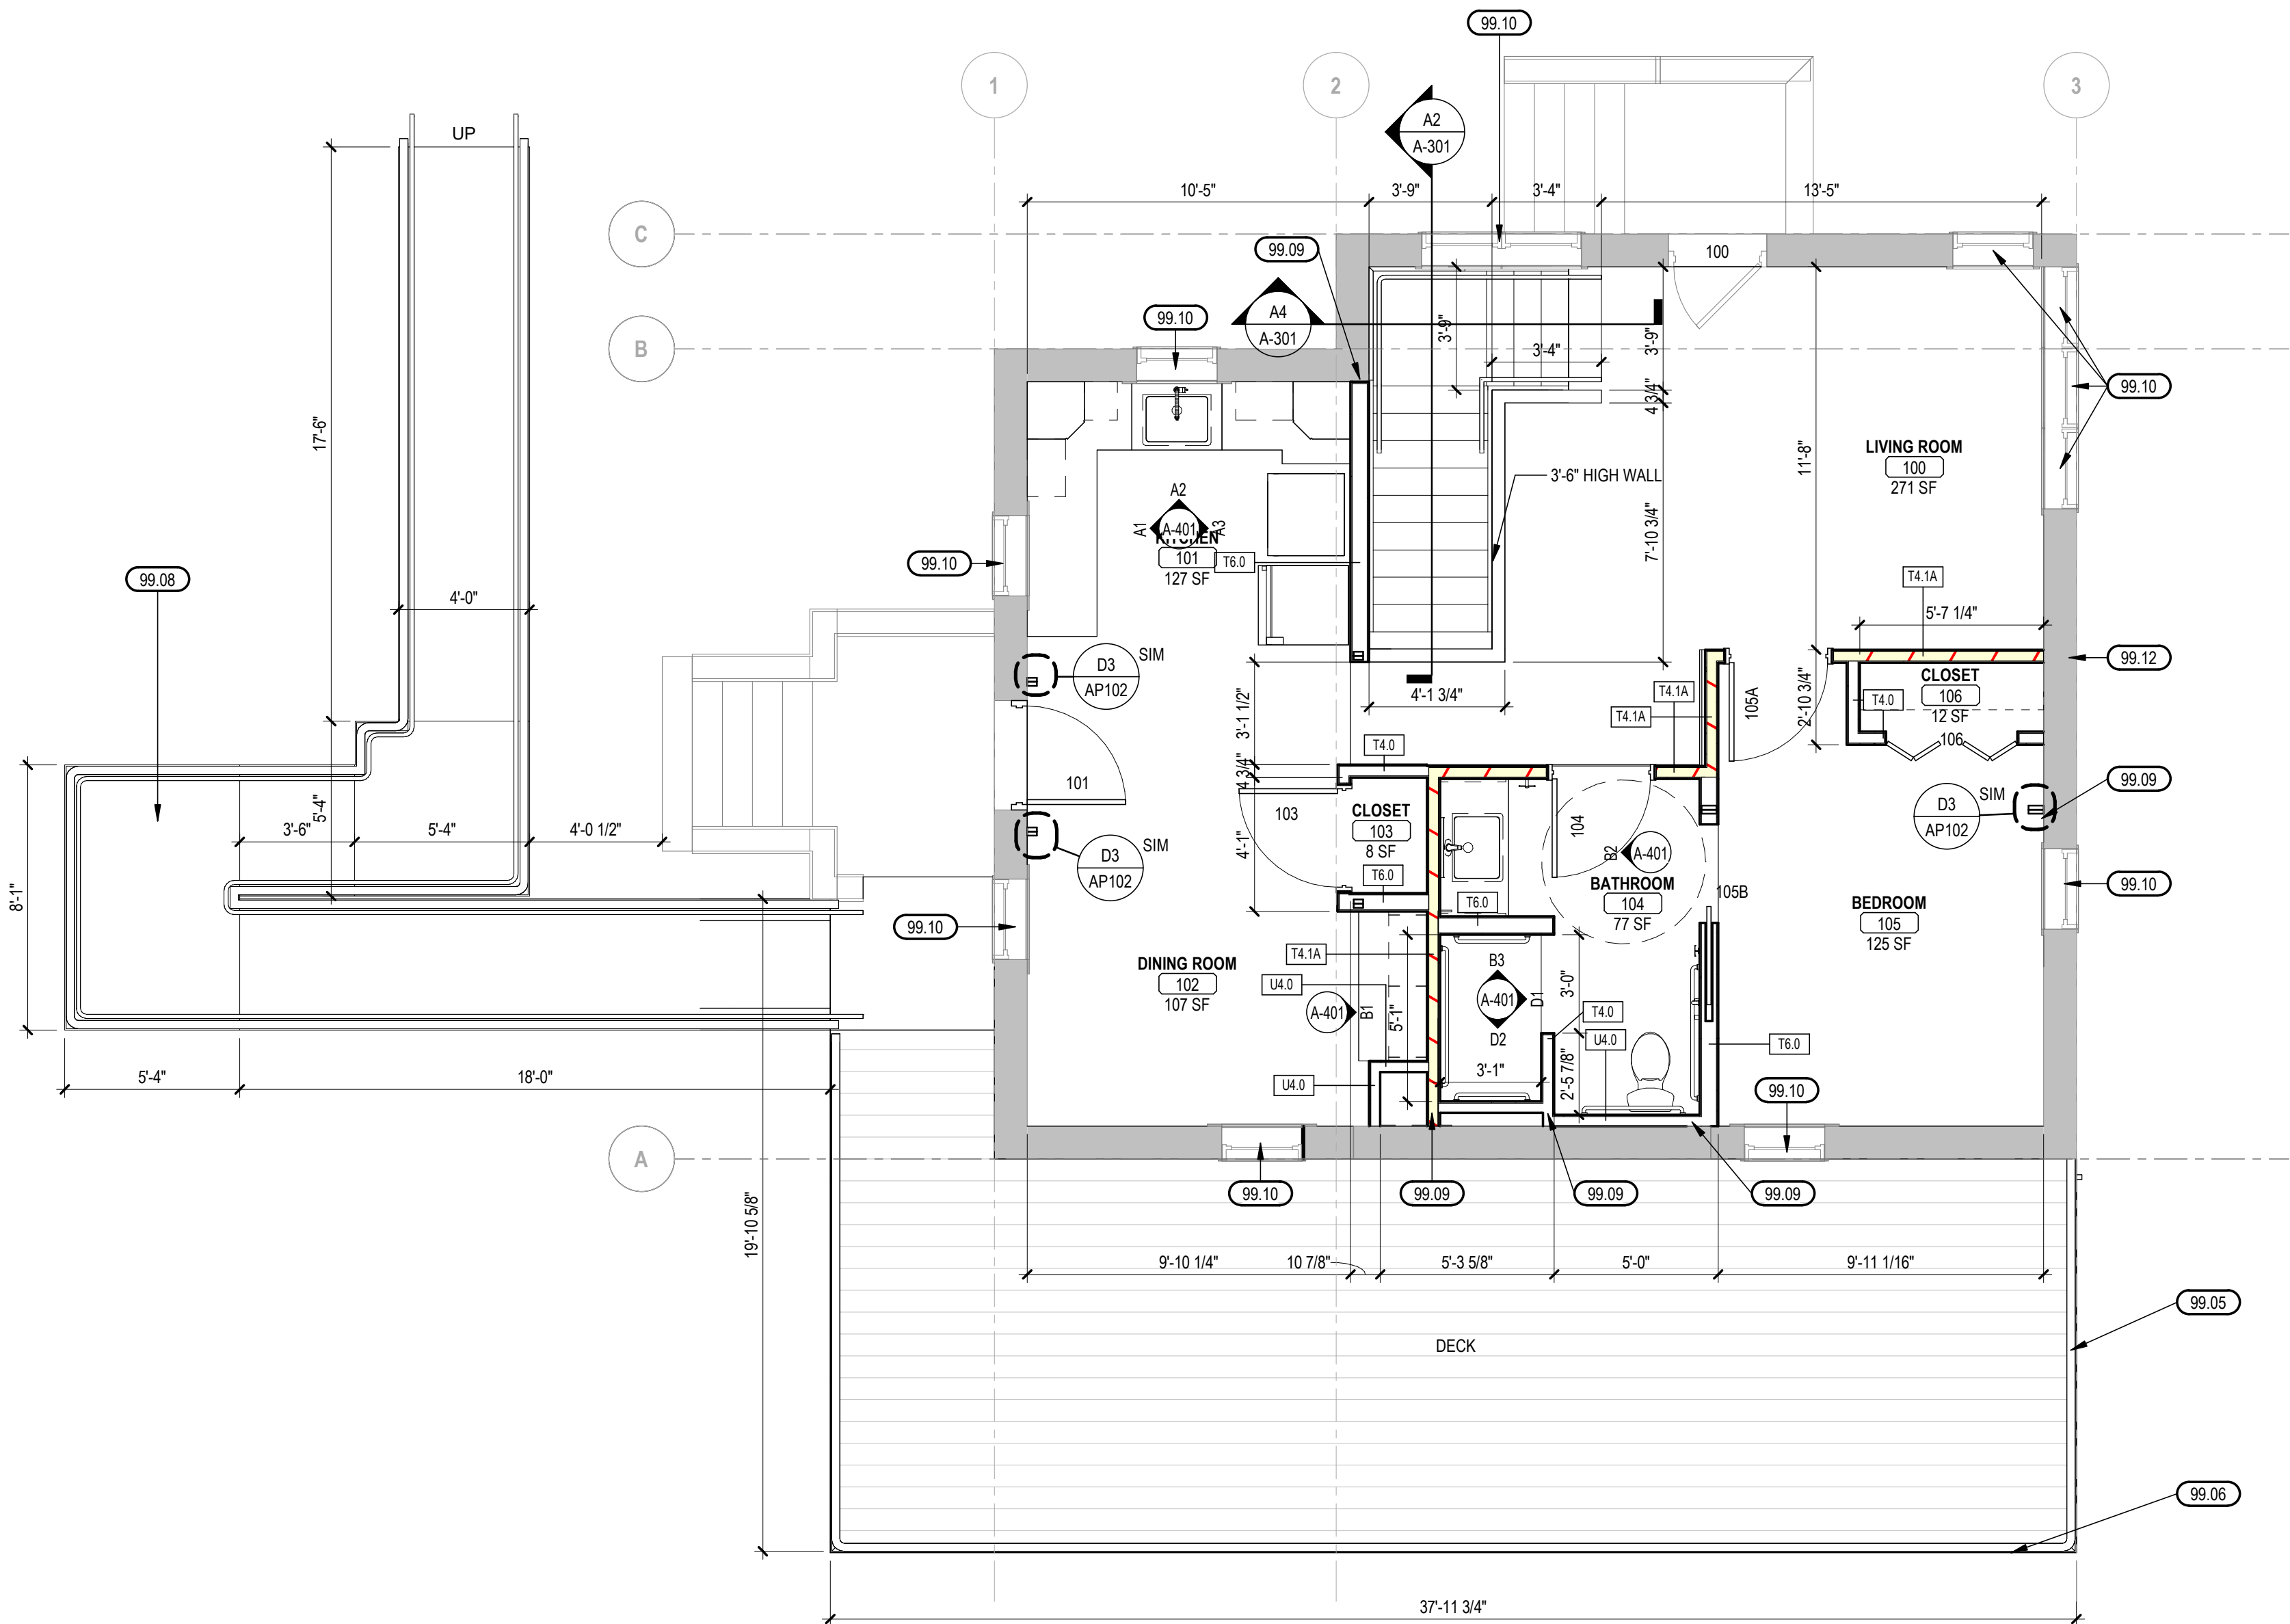
100% CONSTRUCTION DOCUMENTS

L:\TSP\Revit\04032022\1580_SOUTH DAKOTA DEPARTMENT OF THE MILITARY RENOVATE GENERALS QUARTERS DEMO_A22_mitelfelt.rvt
9/15/2023 9:36:29 AM

LISTED DRAWINGS SCALE(S) UNLESS REDUCED FROM ORIGINAL 22 x 34 FORMAT

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9/15/2023 10:30 AM

A1 FIRST LEVEL FLOOR PLAN
SCALE: 1/4" = 1'-0"



FLOOR PLAN GENERAL NOTES

- A. ALL WALLS ARE TYPE T4.0 UNLESS OTHERWISE NOTED.
- B. PROVIDE BLOCKING AT PARTITIONS AS REQUIRED FOR MOUNTING OF FURNISHED AND NON-FURNISHED WALL MOUNTED ITEMS.
- C. ALIGN FINISHED FACE OF CONTINUOUS PARTITIONS THAT CHANGE PARTITION TYPES ALONG A STRAIGHT RUN.
- D. EDGE OF INTERIOR DOOR FRAMES TO BE 4" FROM ADJACENT WALL (6" FROM DOOR PANEL TO ADJACENT WALL), U.N.O.
- E. REFER TO AF101 SHEET FOR DOOR SCHEDULE, DOOR, WINDOW, AND FRAME TYPES.
- F. ALL WALL DIMENSIONS ARE TO FACE OF GYPSUM BOARD, CMU, BRICK, OR CONCRETE, U.N.O.
- G. ASSUME REPLACEMENT OF ALL GYPSUM WALL BOARD IN NEW FIRST FLOOR KITCHEN. CUT AND PATCH OTHER LOCATIONS ON FIRST FLOOR AS NEEDED PER ELECTRICAL AND PLUMBING SHEETS.
- H. REMOVE AND REPLACE ALL FURRING AND SHEETROCK ON THE LOWER LEVEL.

FLOOR PLAN LEGEND

- ROOM NAME**
101
- ROOM TAG**
EXISTING ITEMS TO REMAIN
- NEW WORK W/ DOOR TAG**
CONSTRUCTION LIMITS
- WINDOW TAG**
WALL TAG
- EQUIPMENT TAG**
TA = TOILET ACCESSORIES. SEE SCHEDULE
FE = WALL MOUNTED FIRE EXTINGUISHER
FEC = FIRE EXTINGUISHER CABINET
- REFERENCE KEYNOTE TAG**
T###
- MASONRY CONTROL JOINT**
Gypsum Board Control Joint
- CARD READER**
ELECTRICAL PANEL. REF ELECTRICAL PLANS

REFERENCE KEYNOTES


99.05	TREX TRANSCEND RAILING SYSTEM.
99.06	TREX TRANSCEND LINEAGE COMPOSITE DECKING.
99.08	CONCRETE RAMP W/ TREX GUARDRAIL AND HANDRAIL SYSTEM. CONFIRM EXACT LENGTH REQUIRED IN FIELD. SLOPE 1:12 WITH MAX 3/4" RAIL.
99.09	PATCH WALLS WHERE EXISTING FINISHES WERE REMOVED PRIOR TO APPLYING NEW FINISHES.
99.10	PREP WINDOW FOR NEW STAIN FINISH TO MATCH TRIM TO BE INSTALLED.
99.12	INSPECT ENTIRE BUILDING AND REPAIR FLUOPONT BRICKWORK AS REQUIRED. REPLACE BRICKS AS NECESSARY. UTILIZE BRICKS FROM DEMOLITION.



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**SOUTH DAKOTA
DEPARTMENT OF THE
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RENOVATE GENERALS
QUARTERS BUILDING
250**

RC CAMP RAPID

ISSUES

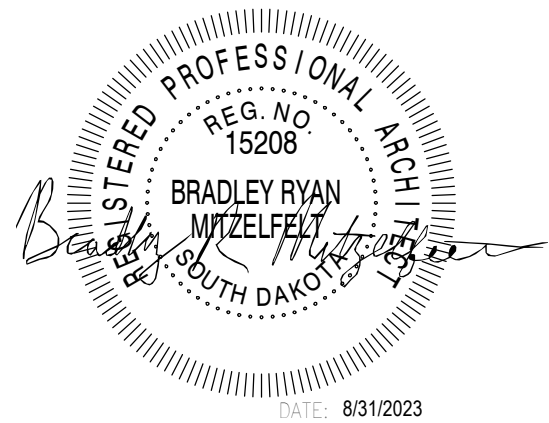ADD02	09/15/2023	ADDENDUM 02
ADD01	09/11/2023	ADDENDUM 01
ISSUE	DATE	DESCRIPTION

ISSUE DATE	DRAWN BY
08/31/2023	BRM
PROJECT #	CHECKED BY
03221580	BRM

SHEET TITLE



**FIRST LEVEL FLOOR
PLAN**

SHEET NUMBER

AP101


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100% CONSTRUCTION DOCUMENTS

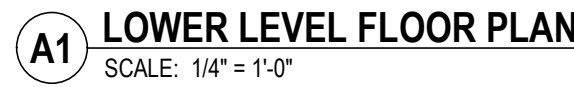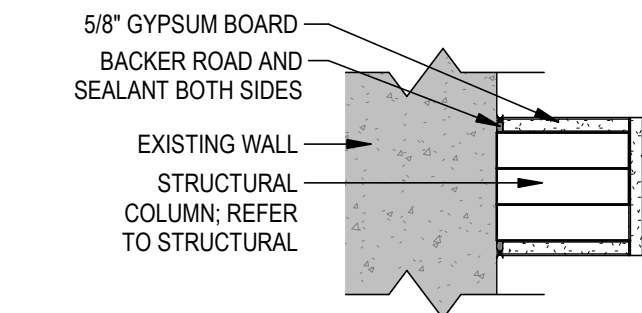


A.	ALL WALLS ARE TYPE T4.0 UNLESS OTHERWISE NOTED.
B.	PROVIDE BLOCKING AT PARTITIONS AS REQUIRED FOR MOUNTING OF FURNISHED AND NON-FURNISHED WALL MOUNTED ITEMS.
C.	ALIGN FINISHED FACE OF CONTINUOUS PARTITIONS THAT CHANGE PARTITION TYPES ALONG A STRAIGHT RUN.
D.	EDGE OF INTERIOR DOOR FRAMES TO BE 4" FROM ADJACENT WALL (6" FROM DOOR PANEL TO ADJACENT WALL), U.N.O.
E.	REFER TO AF101 SHEET FOR DOOR SCHEDULE, DOOR , WINDOW, AND FRAME TYPES.
F.	ALL WALL DIMENSIONS ARE TO FACE OF GYPSUM BOARD, CMU, BRICK, OR CONCRETE, U.N.O.
G.	ASSUME REPLACEMENT OF ALL GYPSUM WALL BOARD IN NEW FIRST FLOOR KITCHEN. CUT AND PATCH OTHER LOCATIONS ON FIRST FLOOR AS NEEDED PER ELECTRICAL AND PLUMBING SHEETS.
H.	REMOVE AND REPLACE ALL FURRING AND SHEETROCK ON THE LOWER LEVEL.


A ADD02	99.09	MATCH WALLS WHERE EXISTING FINISHS WERE REMOVED PRIOR TO APPLYING NEW FINISHES.
	99.11	INFILL WALL WHERE EXISTING ELECTRICAL AND PLATE WERE REMOVED. FINISH EXTERIOR WITH STUCCO TO MATCH EXISTING.
	99.12	INSPECT ENTIRE BUILDING AND REPAIR/TUCKPOINT BRICKWORK AS REQUIRED. REPLACE BRICKS AS NECESSARY. UTILIZE BRICKS FROM DEMOLITION.

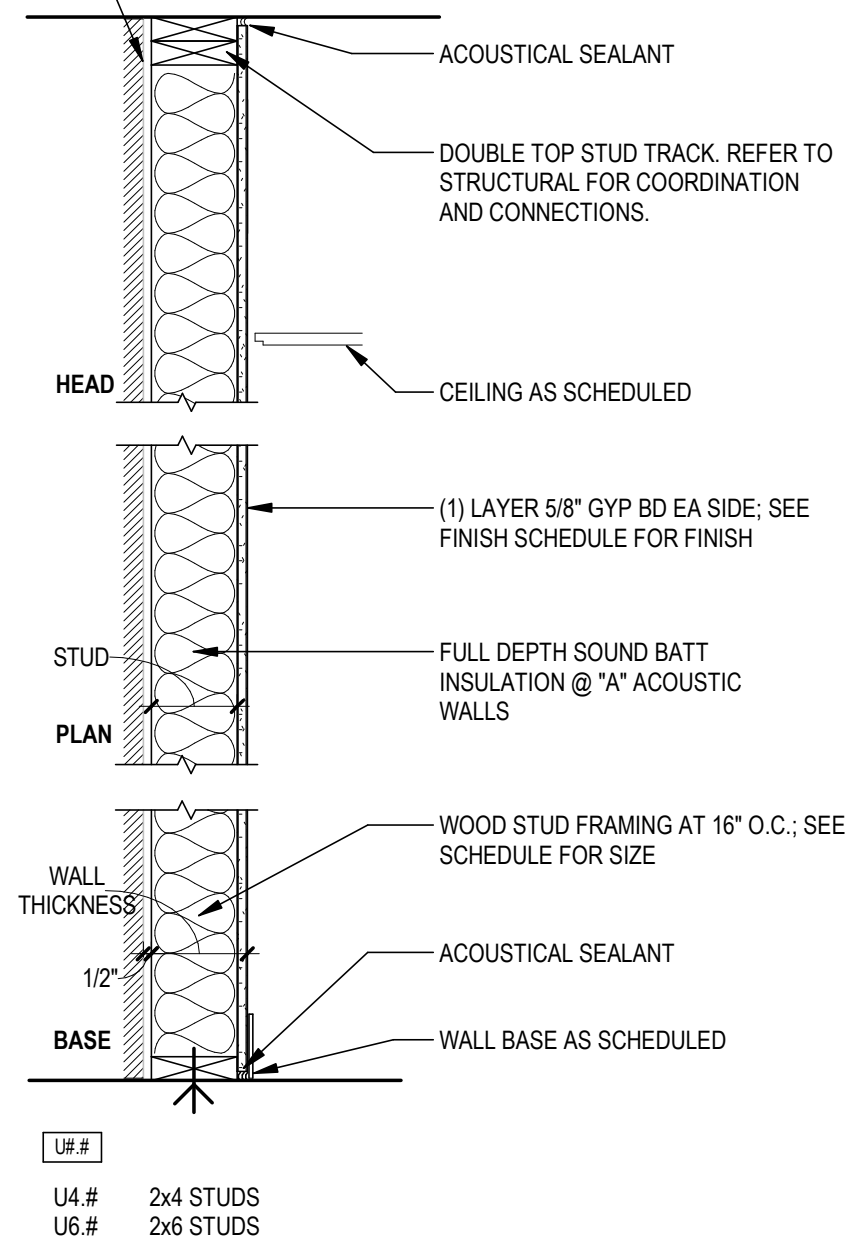

SCALE: 1" = 1'-0"

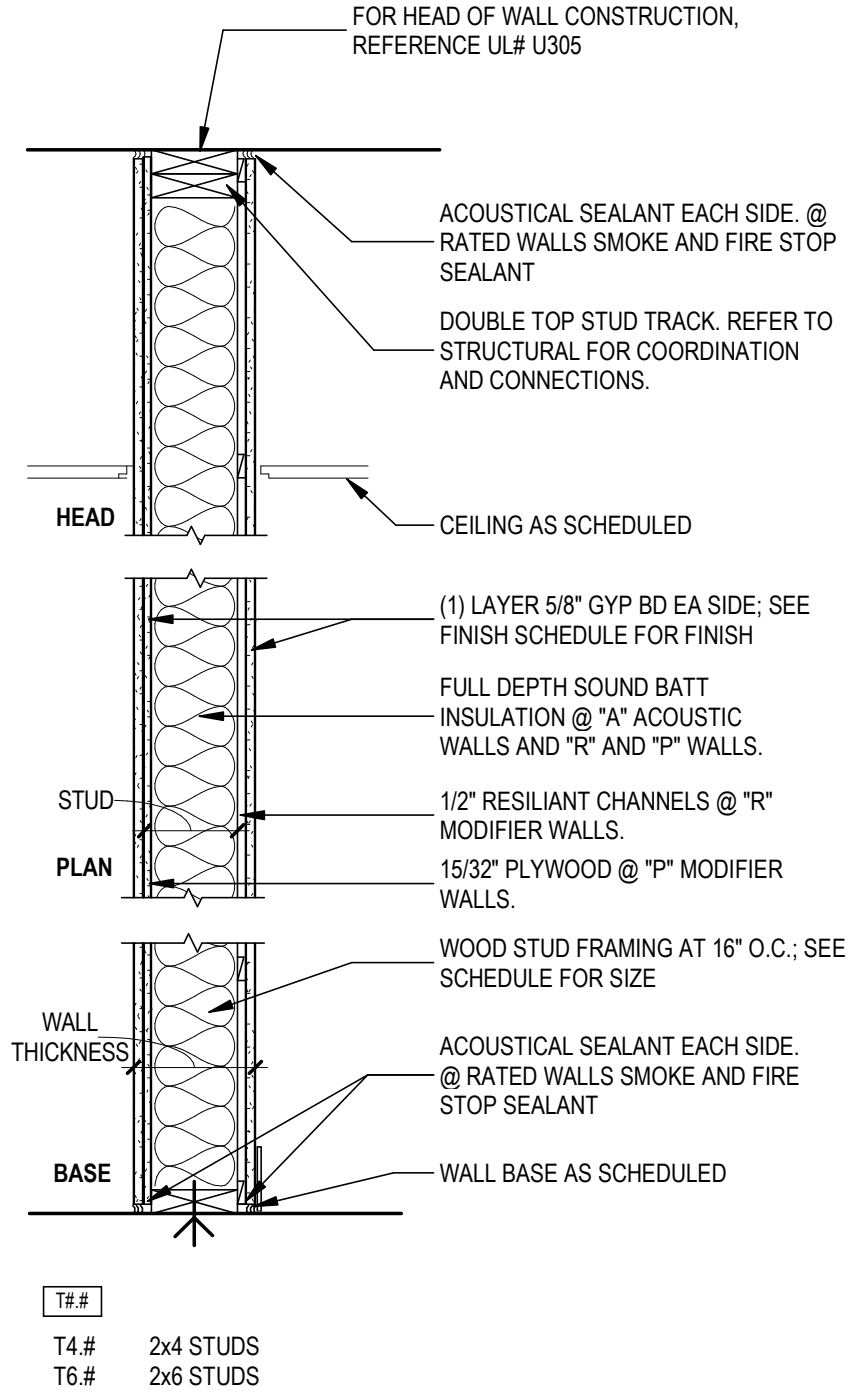


TYPE T - FULL HEIGHT WOOD

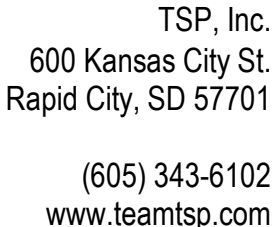

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**SOUTH DAKOTA
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QUARTERS BUILDING
250**

RC CAMP RAPID

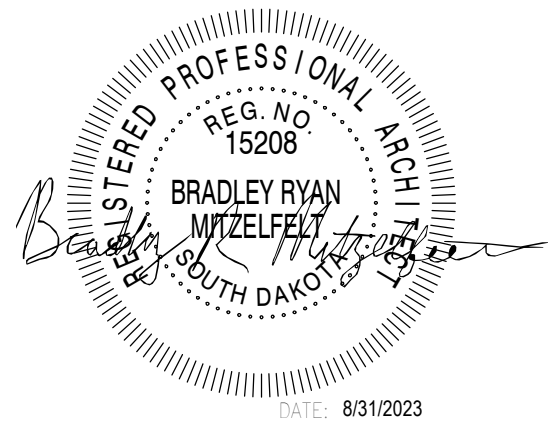ISSUES

ADD02	09/15/2023	ADDENDUM 02
ISSUE	DATE	DESCRIPTION

ISSUE DATE DRAWN BY

08/31/2023 BRM

PROJECT #	CHECKED BY
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03221580 BRM

SHEET TITLE



LOWER LEVEL FLOOR PLAN

SHEET NUMBER



AP102

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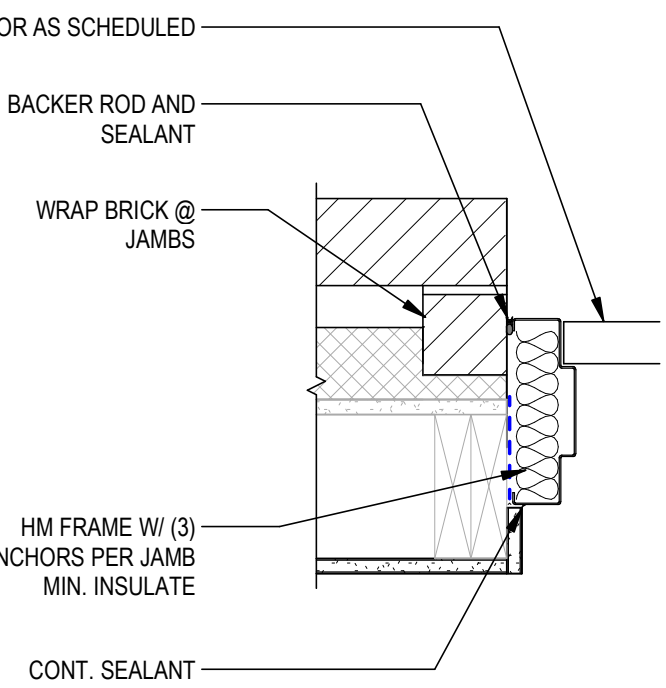
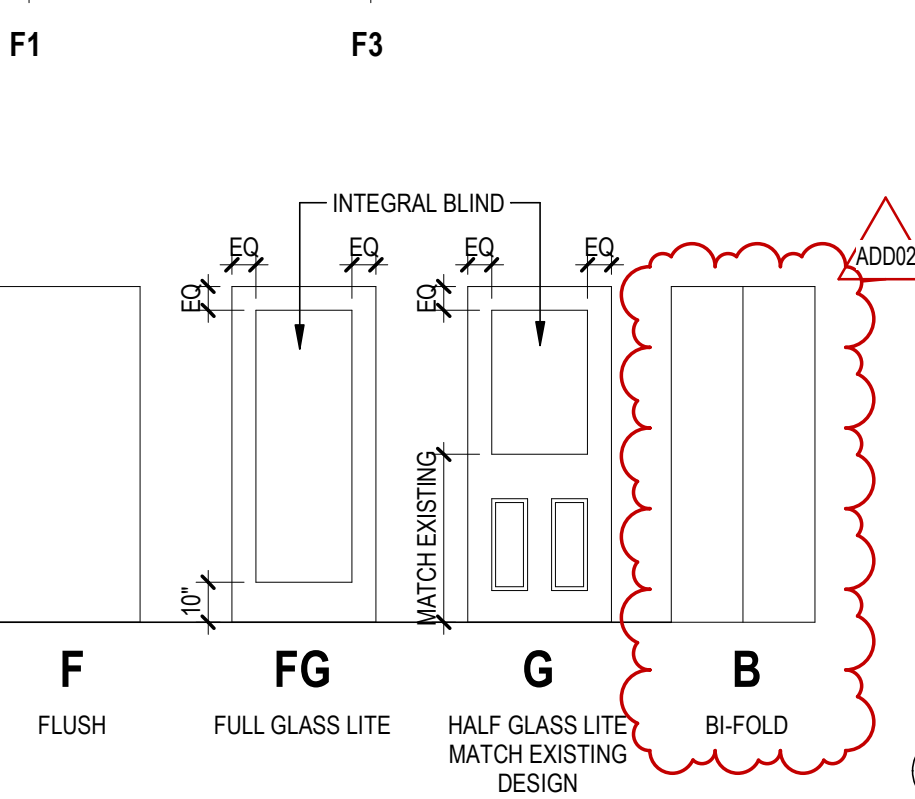
LISTED DRAWINGS SCALE(S) UNLESS REDUCED FROM ORIGINAL 22 x 34 FORMAT

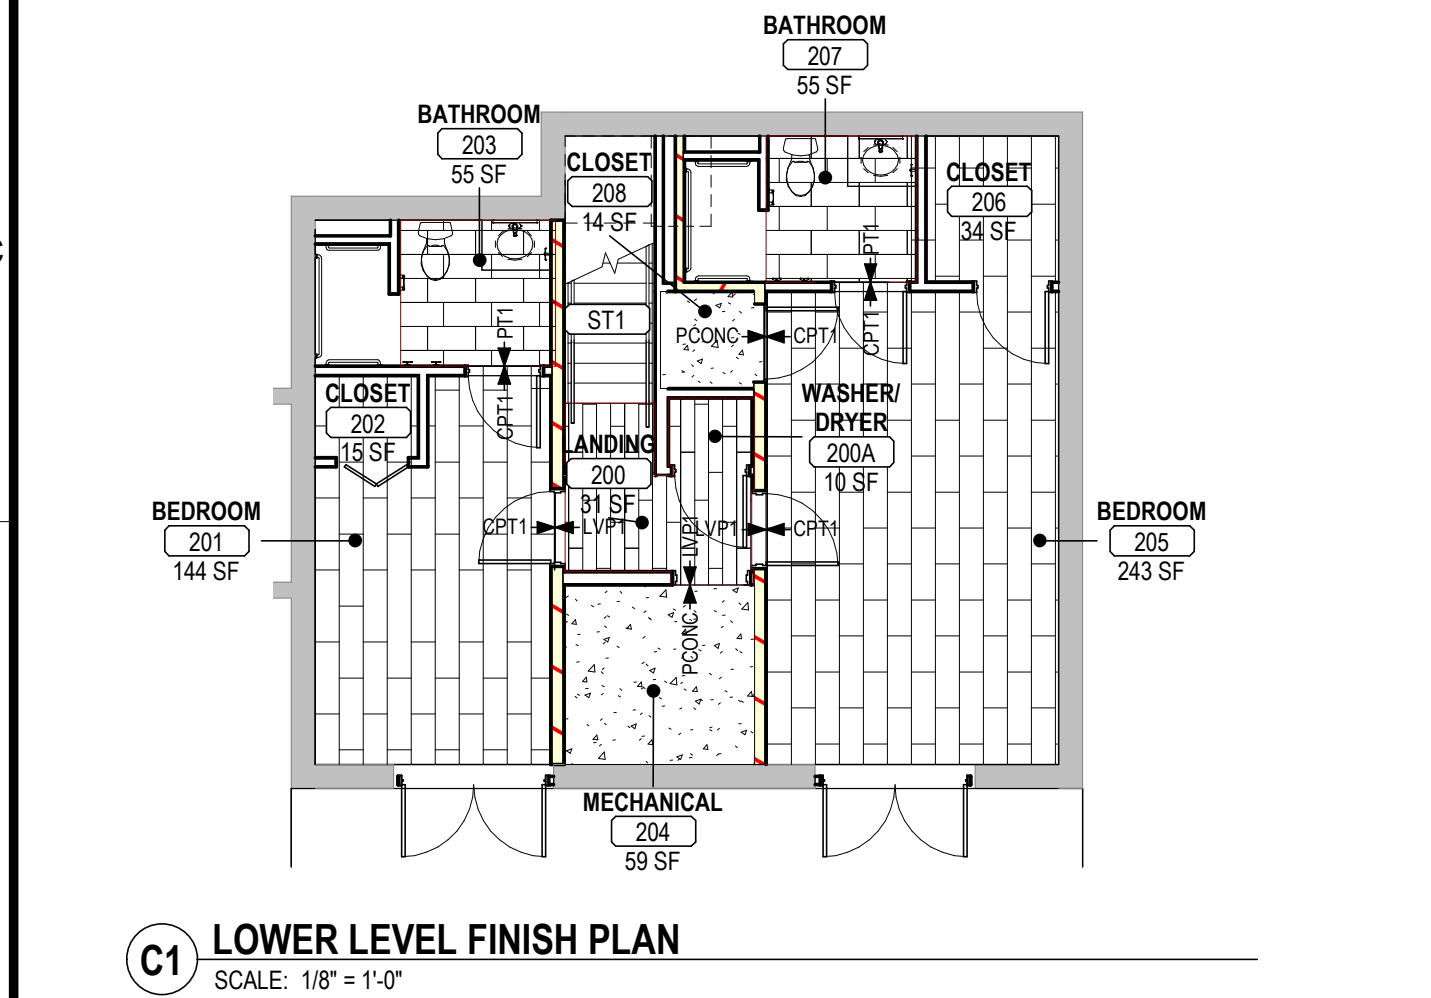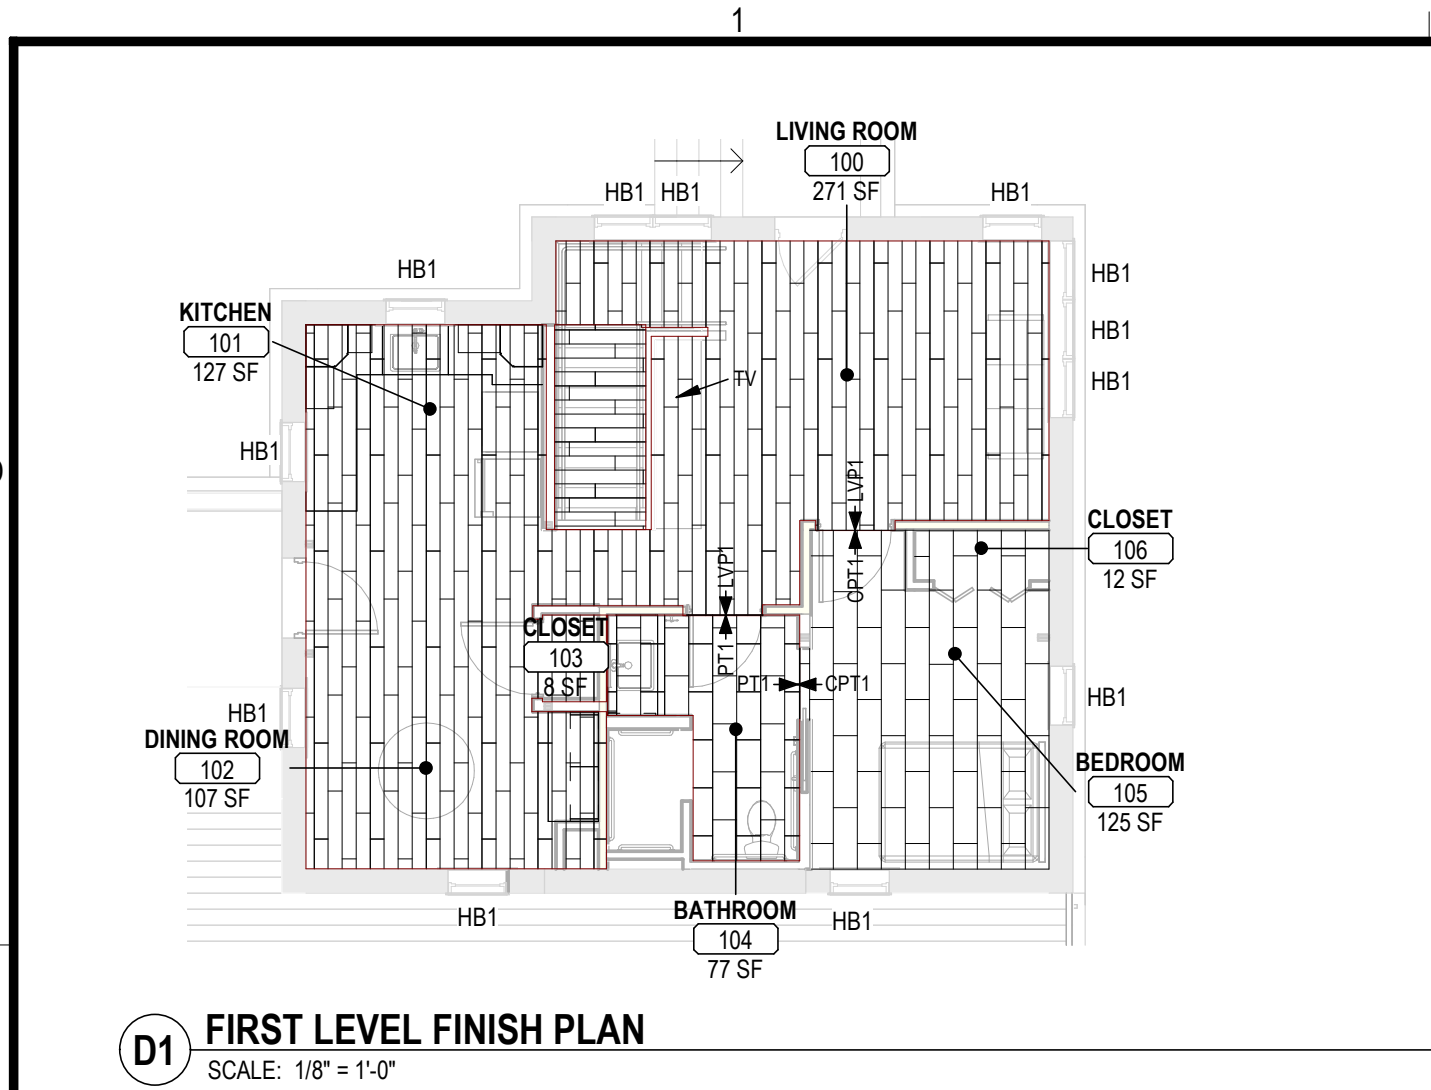

- GENERAL FRAME NOTES:**
- SEE DOOR SCHEDULE FOR DOOR FRAME FINISH
 - SEE DOOR SCHEDULE FOR GLAZING TYPE, U.N.O.
 - ANY/ALL DOORS ARE TO BE INSTALLED AS PER MANUFACTURER'S STANDARDS, DETAILS & INSTRUCTIONS
 - SEE SPECIFICATIONS FOR ANY/ALL ADDITIONAL DOOR & FRAME INFORMATION

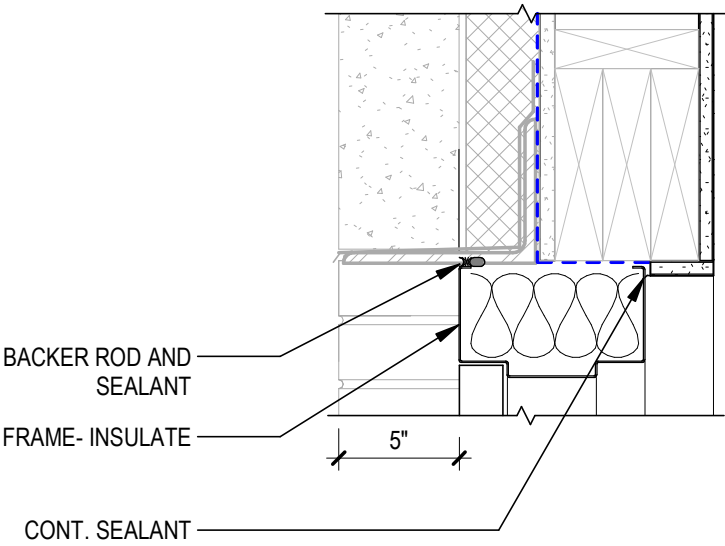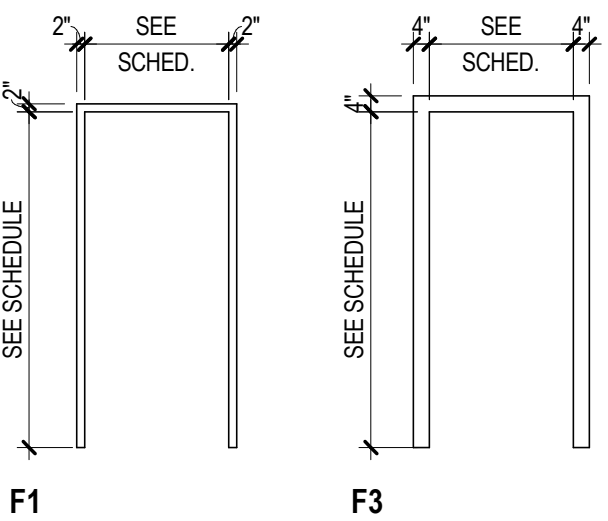

1 DOOR - EXT HM HEAD - MTL STUD/BRICK
SCALE: 1 1/2" = 1'-0"



A2 DOOR - EXT HM JAMB - WD STUD/BRICK
SCALE: 1 1/2" = 1'-0"

FINISH KEY						
SPEC SECTION	CODE	DESCRIPTION	MANUFACTURER	PATTERN	COLOR	NUMBERS
06 20 23	WB	WOOD BASE INTERIOR TRIM	MASTERCRAFT	PINE	UNFINISHED	4172845
06 41 13	WCC1	CABINETRY	WOODLAND	DOOR STYLE: TAYLOR WOOD SPECIES: MDF	PAINT: WHITE	
06 41 13	WCC2	CABINETRY	WOODLAND	DOOR STYLE: TAYLOR WOOD SPECIES: RUSTIC HICKORY	STAIN: SPICE	
09 30 13	PT1	TILE	RAGNOUSA	PORCELAIN FLOOR TILE	ALPINE WHITE	AL45
09 30 13	CT2	TILE	MILESTONE	CERAMIC TILE GLAZED	BALANCE	1102528
09 65 13	RSTA	RUBBER STAIR TREAD NOSING	MANNINGTON COMMERCIAL	575 OVERLAP STAIR NOSING	LIGHT BEIGE	206
09 65 19	LVP1	LVP FLOORING	MANNINGTON COMMERCIAL	SPACIA WOOD	WINDSOR OAK GOLDEN	SSSW12386
09 68 13	CPT1	CARPET	MOHAWK GROUP	DIGITAL TERRAIN	SULPHUR	GT341
09 91 23	P1	PAINT - OVERALL	DIAMOND VOGEL		SANDSTONE PALETTE	0273
09 91 23	P2	PAINT - CEILINGS	DIAMOND VOGEL		DOVE WHITE	0018
09 91 23	P3	PAINT - ACCENT	DIAMOND VOGEL		ATLANTIC WAVES	0473
09 93 00	ST	STAIN	MINWAX		MULBERRY	MW 473
12 21 13	HB1	BLINDS	HUNTER DOUGLAS	APPLAUSE CELLULAR SHADES	GELATO	E26-772
12 36 61.16	SSM1	SOLID SURFACE COUNTERTOP	CORIAN SOLID SURFACE		SANDALWOOD	
12 36 61.16	SSM2	SOLID SURFACE COUNTERTOP	CORIAN SOLID SURFACE		VENARO WHITE	

ROOM FINISH SCHEDULE											
ROOM #	ROOM NAME	FLOOR	BASE	CEILING	WALLS				CASEWORK		REMARKS
					NORTH	EAST	SOUTH	WEST	CABINET	COUNTER	
100	LIVING ROOM	LVP1	WB	P2	P1	P1	P3	P1			
101	KITCHEN	LVP1	WB	P2	P1	P3		P1	WCC1	SSM1	FULL HEIGHT BACKSPLASH
102	DINING ROOM	LVP1	WB	P2	P1	P3	P1	P1	WCC1	SSM1	FULL HEIGHT BACKSPLASH
103	CLOSET	LVP1	WB	P2	P1	P1	P1	P1			
104	BATHROOM	PT1	WB	P2	P3	P1	P1/P3	CT2	WCC2	SSM2	NO BACKSPLASH OR SIDESPLASH FROM COUNTERTOP
105	BEDROOM	CPT1	WB	P2	P1	P3	P1	P1			
106	CLOSET	CPT1	WB	P2	P1	P1	P1	P1			
200	LANDING	LVP1	WB	P2	P1	P1	P1	P1			
200A	WASHER/ DRYER	LVP1	WB	P2	P1	P1	P1	P1			
201	BEDROOM	CPT1	WB	P2	P1	P1	P1	P3			
202	CLOSET	CPT1	WB	P2	P1	P1	P1	P1			
203	BATHROOM	PT1	WB	P2	CT2/P1	P3	P1	CT2/P3	WCC2	SSM2	NO BACKSPLASH OR SIDESPLASH FROM COUNTERTOP
204	MECHANICAL	PCONC	WB	P2	P1	P1	P1	P1			
205	BEDROOM	CPT1	WB	P2	P1	P3	P1	P1			
206	CLOSET	CPT1	WB	P2	P1	P1	P1	P1			
207	BATHROOM	PT1	WB	P2	CT2/P1	P3	P1	CT2/P3	WCC2	SSM2	NO BACKSPLASH OR SIDESPLASH FROM COUNTERTOP
208	CLOSET	PCONC	WB	P2	P1	P1	P1	P1			
ST1	STAIR	LVP1/ RSTA	WB	P2	P1	P1	P1	P1			

DOOR SCHEDULE										
DOOR NO.	WIDTH X HEIGHT	DOOR			FRAME			RATING	HDWR	COMMENTS
		TYPE	MATERIAL	GLAZING	TYPE	MATERIAL	GLAZING			
101	3'-0" x 6'-8"	G	HM	GL3.1 FT	F3	HM	-	-		INTEGRAL BLIND
103	3'-0" x 6'-8"	F	WD	-	F1	WD	-	-		
104	3'-0" x 6'-8"	F	WD	-	F1	WD	-	45MIN		
105A	3'-0" x 6'-8"	F	WD	-	F1	WD	-	45MIN		
105B	3'-0" x 6'-8"	F	WD	-	F1	WD	-	-		POCKET DOOR
106	4'-0" x 6'-8"	B	WD	-	F1	WD	-	-		4 PANELS
200	3'-0" x 6'-8"	F	WD	-	F1	WD	-	-		
201A	3'-0" x 6'-8"	F	WD	-	F1	WD	-	45MIN		
201B	6'-0" x 6'-8"	FG	HM	GL3.1 FT	F3	HM	-	-	1	INTEGRAL BLIND
202	3'-0" x 6'-8"	B	WD	-	F1	WD	-	-		2 PANELS
203	3'-0" x 6'-8"	F	WD	-	F1	WD	-	-		
204	3'-0" x 6'-8"	F	WD	-	F1	WD	-	-		
205A	3'-0" x 6'-8"	F	WD	-	F1	WD	-	45MIN		
205B	6'-0" x 6'-8"	FG	HM	GL3.1 FT	F3	HM	-	-	1	INTEGRAL BLIND
206	3'-0" x 6'-8"	F	WD	-	F1	WD	-	-		
207	3'-0" x 6'-8"	F	WD	-	F1	WD	-	-		
208	3'-0" x 6'-8"	F	WD	-	F1	WD	-	45MIN		

GLAZING LEGEND

GL3.1 = 1" INSULATING CLEAR

ALL GLASS TO BE HEAT STRENGTHENED UNLESS DESIGNATED AS "FT" SUFFIX (FULLY TEMPERED)

FINISH PLAN GENERAL NOTES

- CLEAN ALL EXPOSED SURFACES PRIOR TO PRIMING AND PAINTING.
- PAINT ALL EXPOSED DUCTWORK, STRUCTURE, CONDUIT, ELECTRICAL BOXES, AND SIMILAR, U.N.O.
- PAINT ALL EXPOSED CMU AND GYP BD, U.N.O.
- SEE REFLECTED CEILING PLANS FOR SOFFIT LOCATIONS AND HEIGHTS
- PROVIDE APPROPRIATE FLOORING TRANSITION TYPE. (CENTER UNDER DOOR AT DOOR LOCATIONS)

FINISH PLAN LEGEND

ROOM NAME	ROOM TAG
101	
CPT1	FINISH TRANSITION
7###	REFERENCE KEYNOTE TAG
	LVP1 HORIZONTAL LAY PATTERN
	LVP1 VERTICAL LAY PATTERN
	PT1
	CPT1
	PCONC

DOOR SCHEDULE ABBREVIATIONS

AL	ALUMINUM
EX	EXISTING
HM	HOLLOW METAL
IHM	INSULATED HOLLOW METAL
WD	WOOD
SS	STAINLESS STEEL

ROOM FINISH SCHEDULE GENERAL NOTES

- PAINT ALL EXPOSED STRUCTURE. U.N.O.

ROOM FINISH SCHEDULE REMARKS

- PROVIDE FLOORING TRANSITIONS AT EVERY CHANGE OF MATERIAL. TRANSITIONS SHOULD OCCUR UNDER THE CENTER OF THE DOOR.
- FLOORING TRANSITIONS:
 - SHEET VINYL / LUXURY VINYL PLANK OR TILE: BUTT JOINT
 - RESILIENT FLOORING / CARPET TILE: SCHLUTER SCHIENE STAINLESS STEEL
 - RESILIENT FLOORING / CONCRETE: SCHLUTER RENO RAMP STAINLESS STEEL
 - RESILIENT FLOORING / PORCELAIN TILE: SCHLUTER SCHIENE STAINLESS STEEL
 - PORCELAIN WALL TILE OUTSIDE CORNERS: SCHLUTER QUADREC STAINLESS STEEL
 - EXPOSED EDGE OF WALL TILE: SCHLUTER DILEX STAINLESS STEEL
 - PORCELAIN TILE / WALL TILE: SCHLUTER DILEX STAINLESS STEEL
 - WALL TILE, INSIDE OR OUTSIDE CORNER WHERE CHANGING FROM ONE TILE SIZE TO ANOTHER AND THE HORIZONTAL GROUT JOINTS WILL NOT LINE UP:
 - INSIDE CORNERS: SCHLUTER DILEX STAINLESS STEEL
 - OUTSIDE CORNERS: SCHLUTER QUADREC STAINLESS STEEL
 - FLOAT UP VINYL TO BE FLUSH WITH TRANSITION STRIP
 - INTEGRAL COVE SHEET VINYL: HEAT WELD TO MATCH SPECKLE, 6" HIGH
 - INTEGRAL BASE WITH BONDED STAINLESS STEEL CAP, PUNCTURE PROOF
 - ALUMINUM COVE REINFORCEMENT.
- CG: CORNER GUARD, PROVIDE ON ALL OUTSIDE CORNERS
- WP: VINYL WALL PROTECTION
- COUNTERTOPS:
 - COUNTERTOPS WITHOUT SINKS: 1-1/8" THICK PLASTIC LAMINATE WITH 3MM EDGES AND INTEGRAL BACKSPLASH.
 - COUNTERTOPS WITH SINKS: 1-1/2" THICK PLASTIC LAMINATE WITH DOUBLE BULLNOSE (R-1/4" TOP AND BOTTOM) RETURN LAMINATE 1" UNDER COUNTERTOP, INTEGRAL BACKSPLASH.
 - ALL COUNTERTOPS TO HAVE 1-1/2" RADIUS ON ALL OUTSIDE CORNERS.
 - SOLID SURFACE COUNTERTOPS TO BE 1-1/2" THICK WITH EASED EDGES.

STANDARD INTERIOR ABBREVIATIONS

APC	ACOUSTICAL PANEL CEILING
AWP	ACOUSTICAL WALL PANEL
BCMU	BURNISHED CONCRETE MASONRY UNIT
CG	CORNER GUARD
CMU	CONCRETE MASONRY UNIT
CONC	CONCRETE
CPT	CARPET
CT	CERAMIC TILE
DCMU	DECORATIVE CONCRETE MASONRY UNITS
EP	EPOXY PAINT
EPF	EPOXY FLOORING
FRP	FIBERGLASS REINFORCED PANEL
GLT	GLASS TILE
GT	GROUT
GWB	GYP SUM WALL BOARD
LVT	LUXURY VINYL TILE
MB	METAL BASE
MPC	METAL PANEL CEILING
P	PAINT
PCONC	POLISHED CONCRETE
PLAM	PLASTIC LAMINATE
PT	PORCELAIN TILE
PTB	PORCELAIN TILE BASE
QT	QUARRY TILE
QTB	QUARRY TILE BASE
RAF	RESILIENT ATHLETIC FLOORING
RBR	RUBBER FLOORING
RBRT	RUBBER TILE FLOORING
RBRF	RUBBER SHEET FLOORING
RSTA	RUBBER STAIR TREAD / NOSING
RP	RESINOUS PANEL
SCONC	SEALED CONCRETE
SCMU	SPLIT FACED CONCRETE MASORY UNIT
SSMU	SOLID SURFACE MATERIAL
ST	STAIN
STCONC	STAINED CONCRETE
SVF	SHEET VINYL FLOORING
TER	TERRAZZO
RB	RESILIENT BASE
VCT	VINYL COMPOSITION TILE
VWC	VINYL WALL COVERING
WB	WOOD BASE
WCPT	WALK-OFF CARPET TILE
WP	WALL PROTECTION
WPC	WOOD PANEL CEILING
WG	WALL GUARD




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**SOUTH DAKOTA
DEPARTMENT OF THE
MILITARY
RENOVATE GENERALS
QUARTERS BUILDING
250**

RC CAMP RAPID

ISSUES

ISSUE	DATE	DESCRIPTION
ISSUE DATE	08/31/2023	DRAWN BY MPP
PROJECT #	03221580	CHECKED BY BRM
SHEET TITLE		

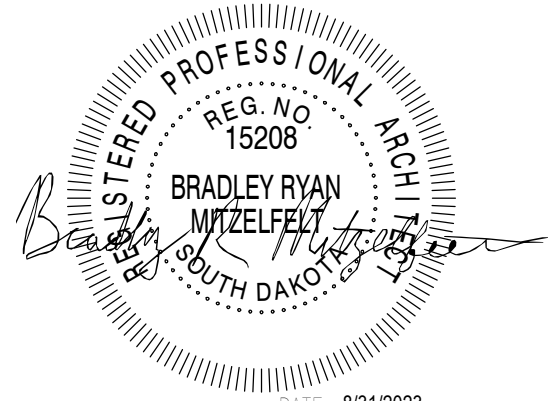**FINISH FLOOR PLAN
AND SCHEDULES**

SHEET NUMBER


AF101

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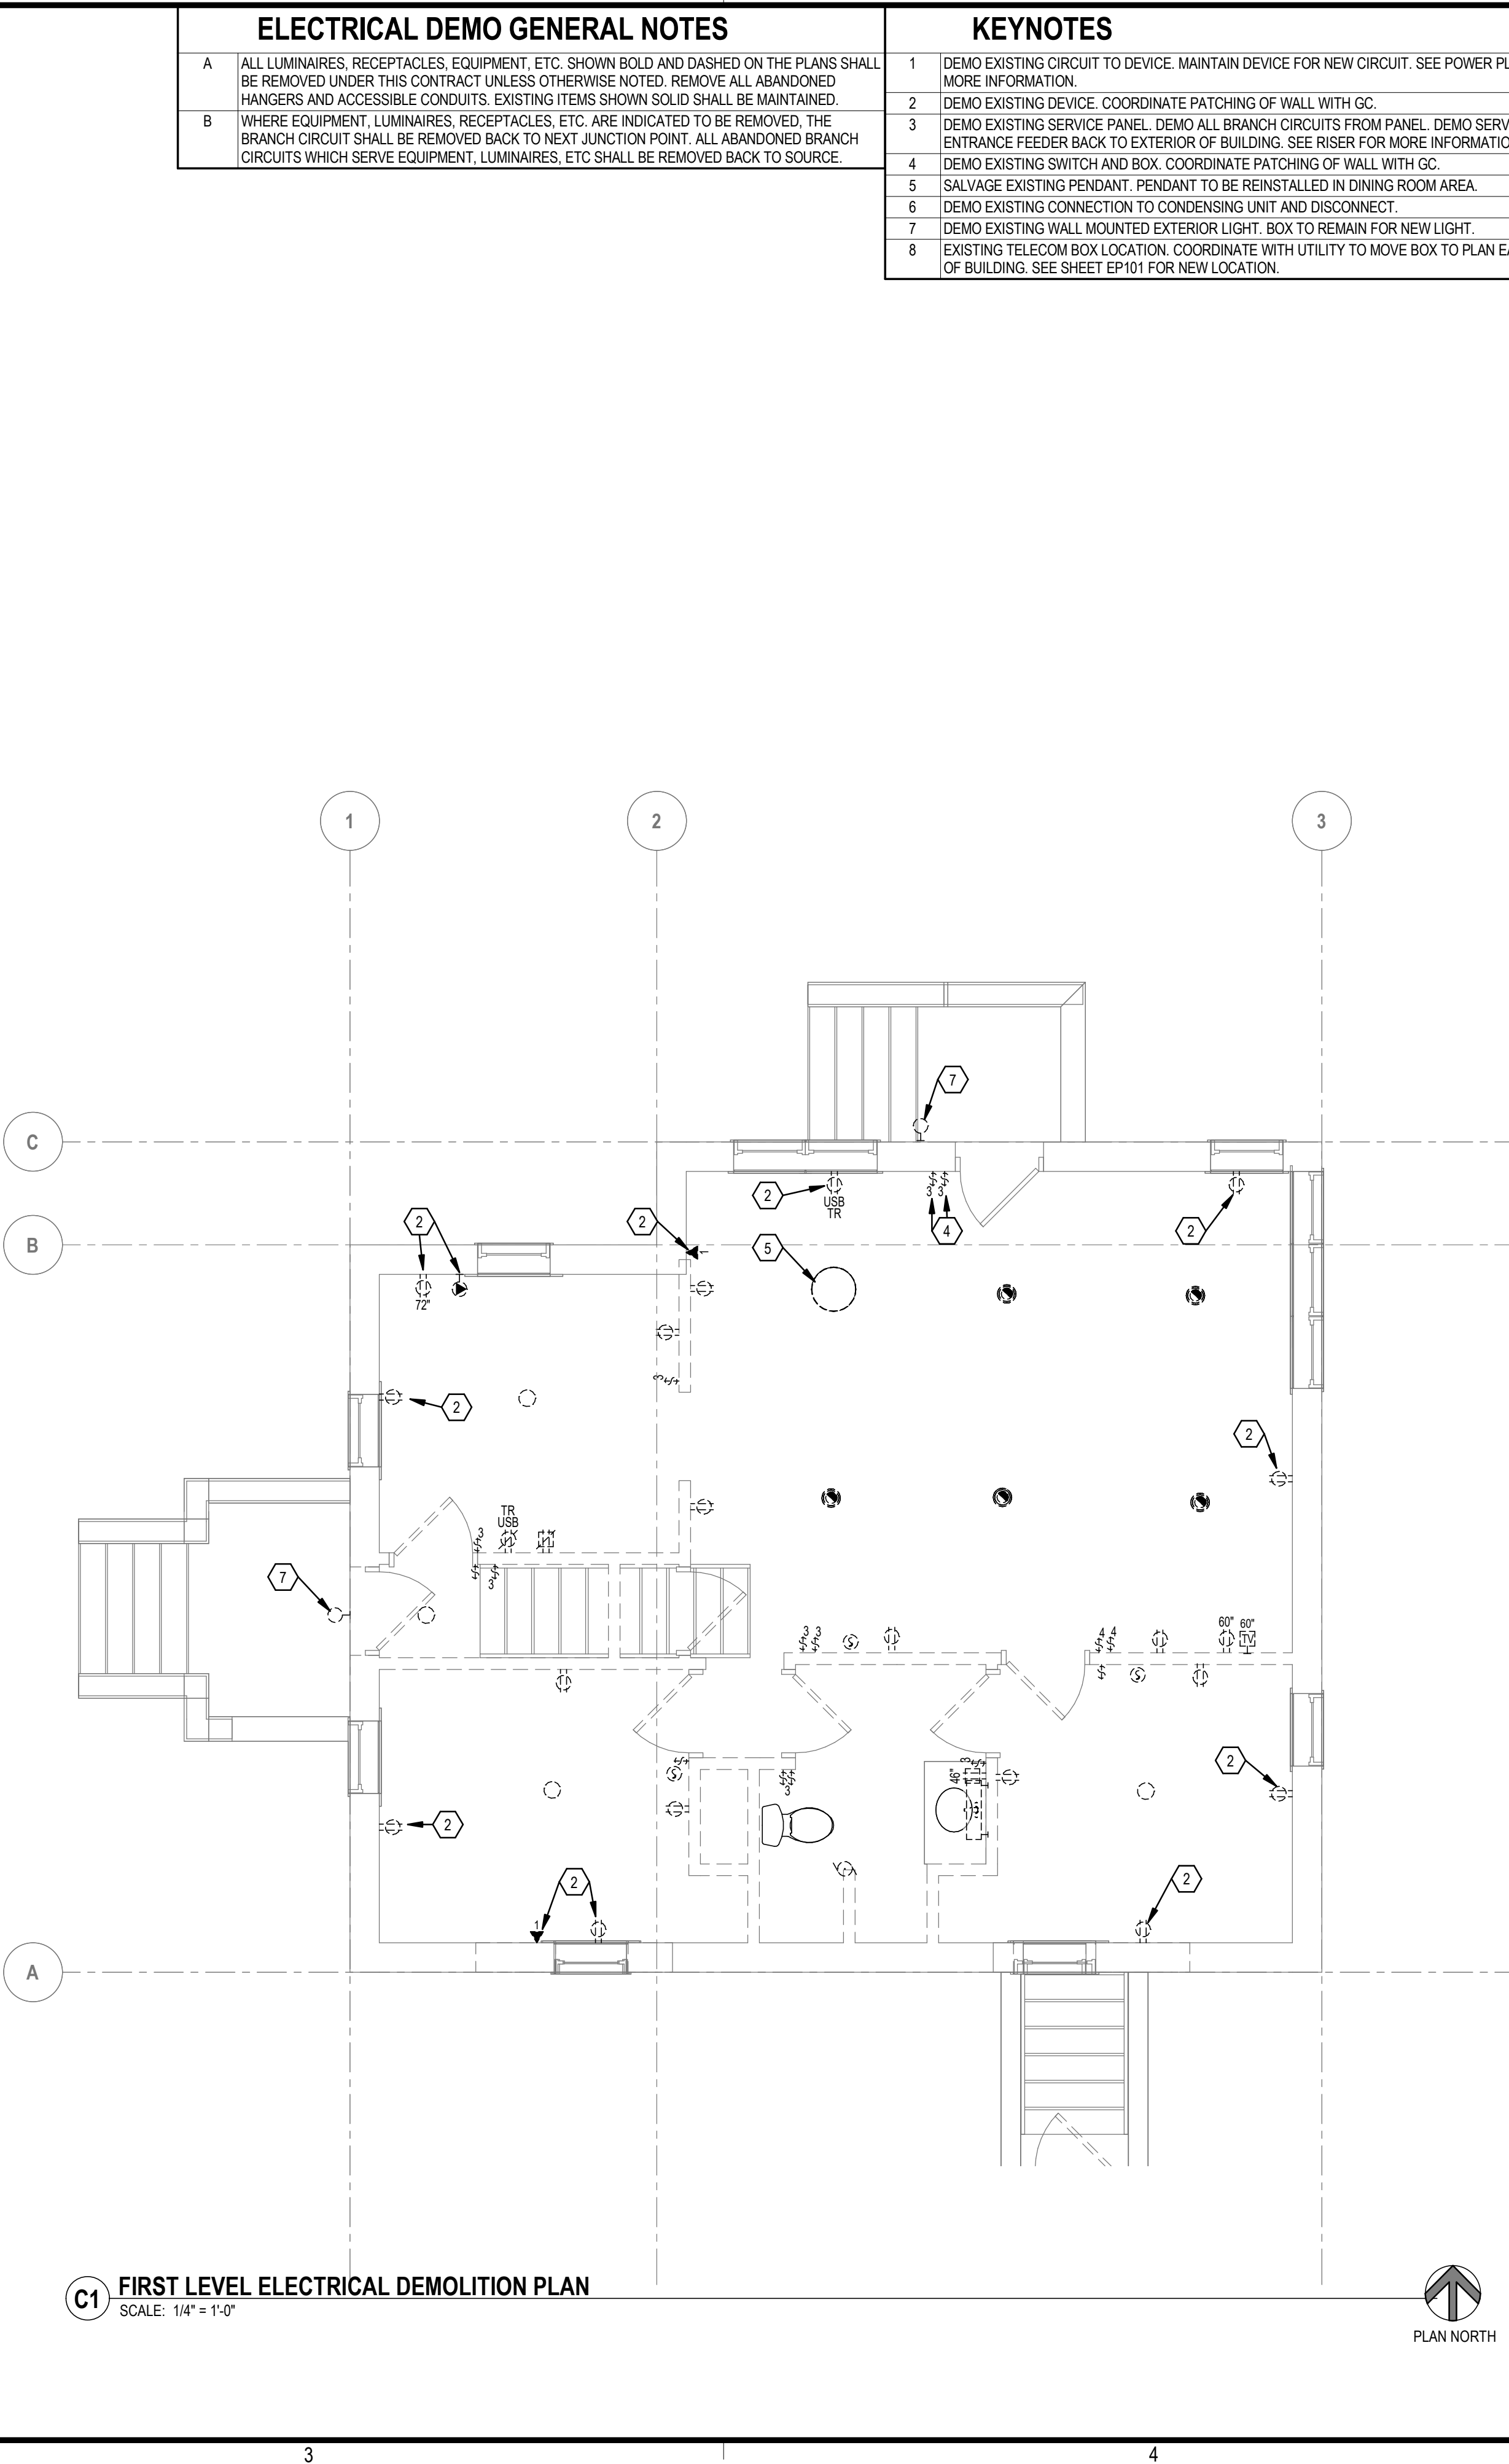
LISTED DRAWINGS SCALE(S) UNLESS REDUCED FROM ORIGINAL 22 x 34 FORMAT

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ELECTRICAL DEMO GENERAL NOTES	
A	ALL LUMINAIRES, RECEPTACLES, EQUIPMENT, ETC. SHOWN BOLD AND DASHED ON THE PLANS SHALL BE REMOVED UNDER THIS CONTRACT UNLESS OTHERWISE NOTED. REMOVE ALL ABANDONED HANGERS AND ACCESSIBLE CONDUITS. EXISTING ITEMS SHOWN SOLID SHALL BE MAINTAINED.
B	WHERE EQUIPMENT, LUMINAIRES, RECEPTACLES, ETC. ARE INDICATED TO BE REMOVED, THE BRANCH CIRCUIT SHALL BE REMOVED BACK TO NEXT JUNCTION POINT. ALL ABANDONED BRANCH CIRCUITS WHICH SERVE EQUIPMENT, LUMINAIRES, ETC SHALL BE REMOVED BACK TO SOURCE.

KEYNOTES	
1	DEMO EXISTING CIRCUIT TO DEVICE. MAINTAIN DEVICE FOR NEW CIRCUIT. SEE POWER PLAN FOR MORE INFORMATION.
2	DEMO EXISTING DEVICE. COORDINATE PATCHING OF WALL WITH GC.
3	DEMO EXISTING SERVICE PANEL. DEMO ALL BRANCH CIRCUITS FROM PANEL. DEMO SERVICE ENTRANCE FEEDER BACK TO EXTERIOR OF BUILDING. SEE RISER FOR MORE INFORMATION.
4	DEMO EXISTING SWITCH AND BOX. COORDINATE PATCHING OF WALL WITH GC.
5	SALVAGE EXISTING PENDANT. PENDANT TO BE REINSTALLED IN DINING ROOM AREA.
6	DEMO EXISTING CONNECTION TO CONDENSING UNIT AND DISCONNECT.
7	DEMO EXISTING WALL MOUNTED EXTERIOR LIGHT. BOX TO REMAIN FOR NEW LIGHT.
8	EXISTING TELECOM BOX LOCATION. COORDINATE WITH UTILITY TO MOVE BOX TO PLAN EAST SIDE OF BUILDING. SEE SHEET EP101 FOR NEW LOCATION.

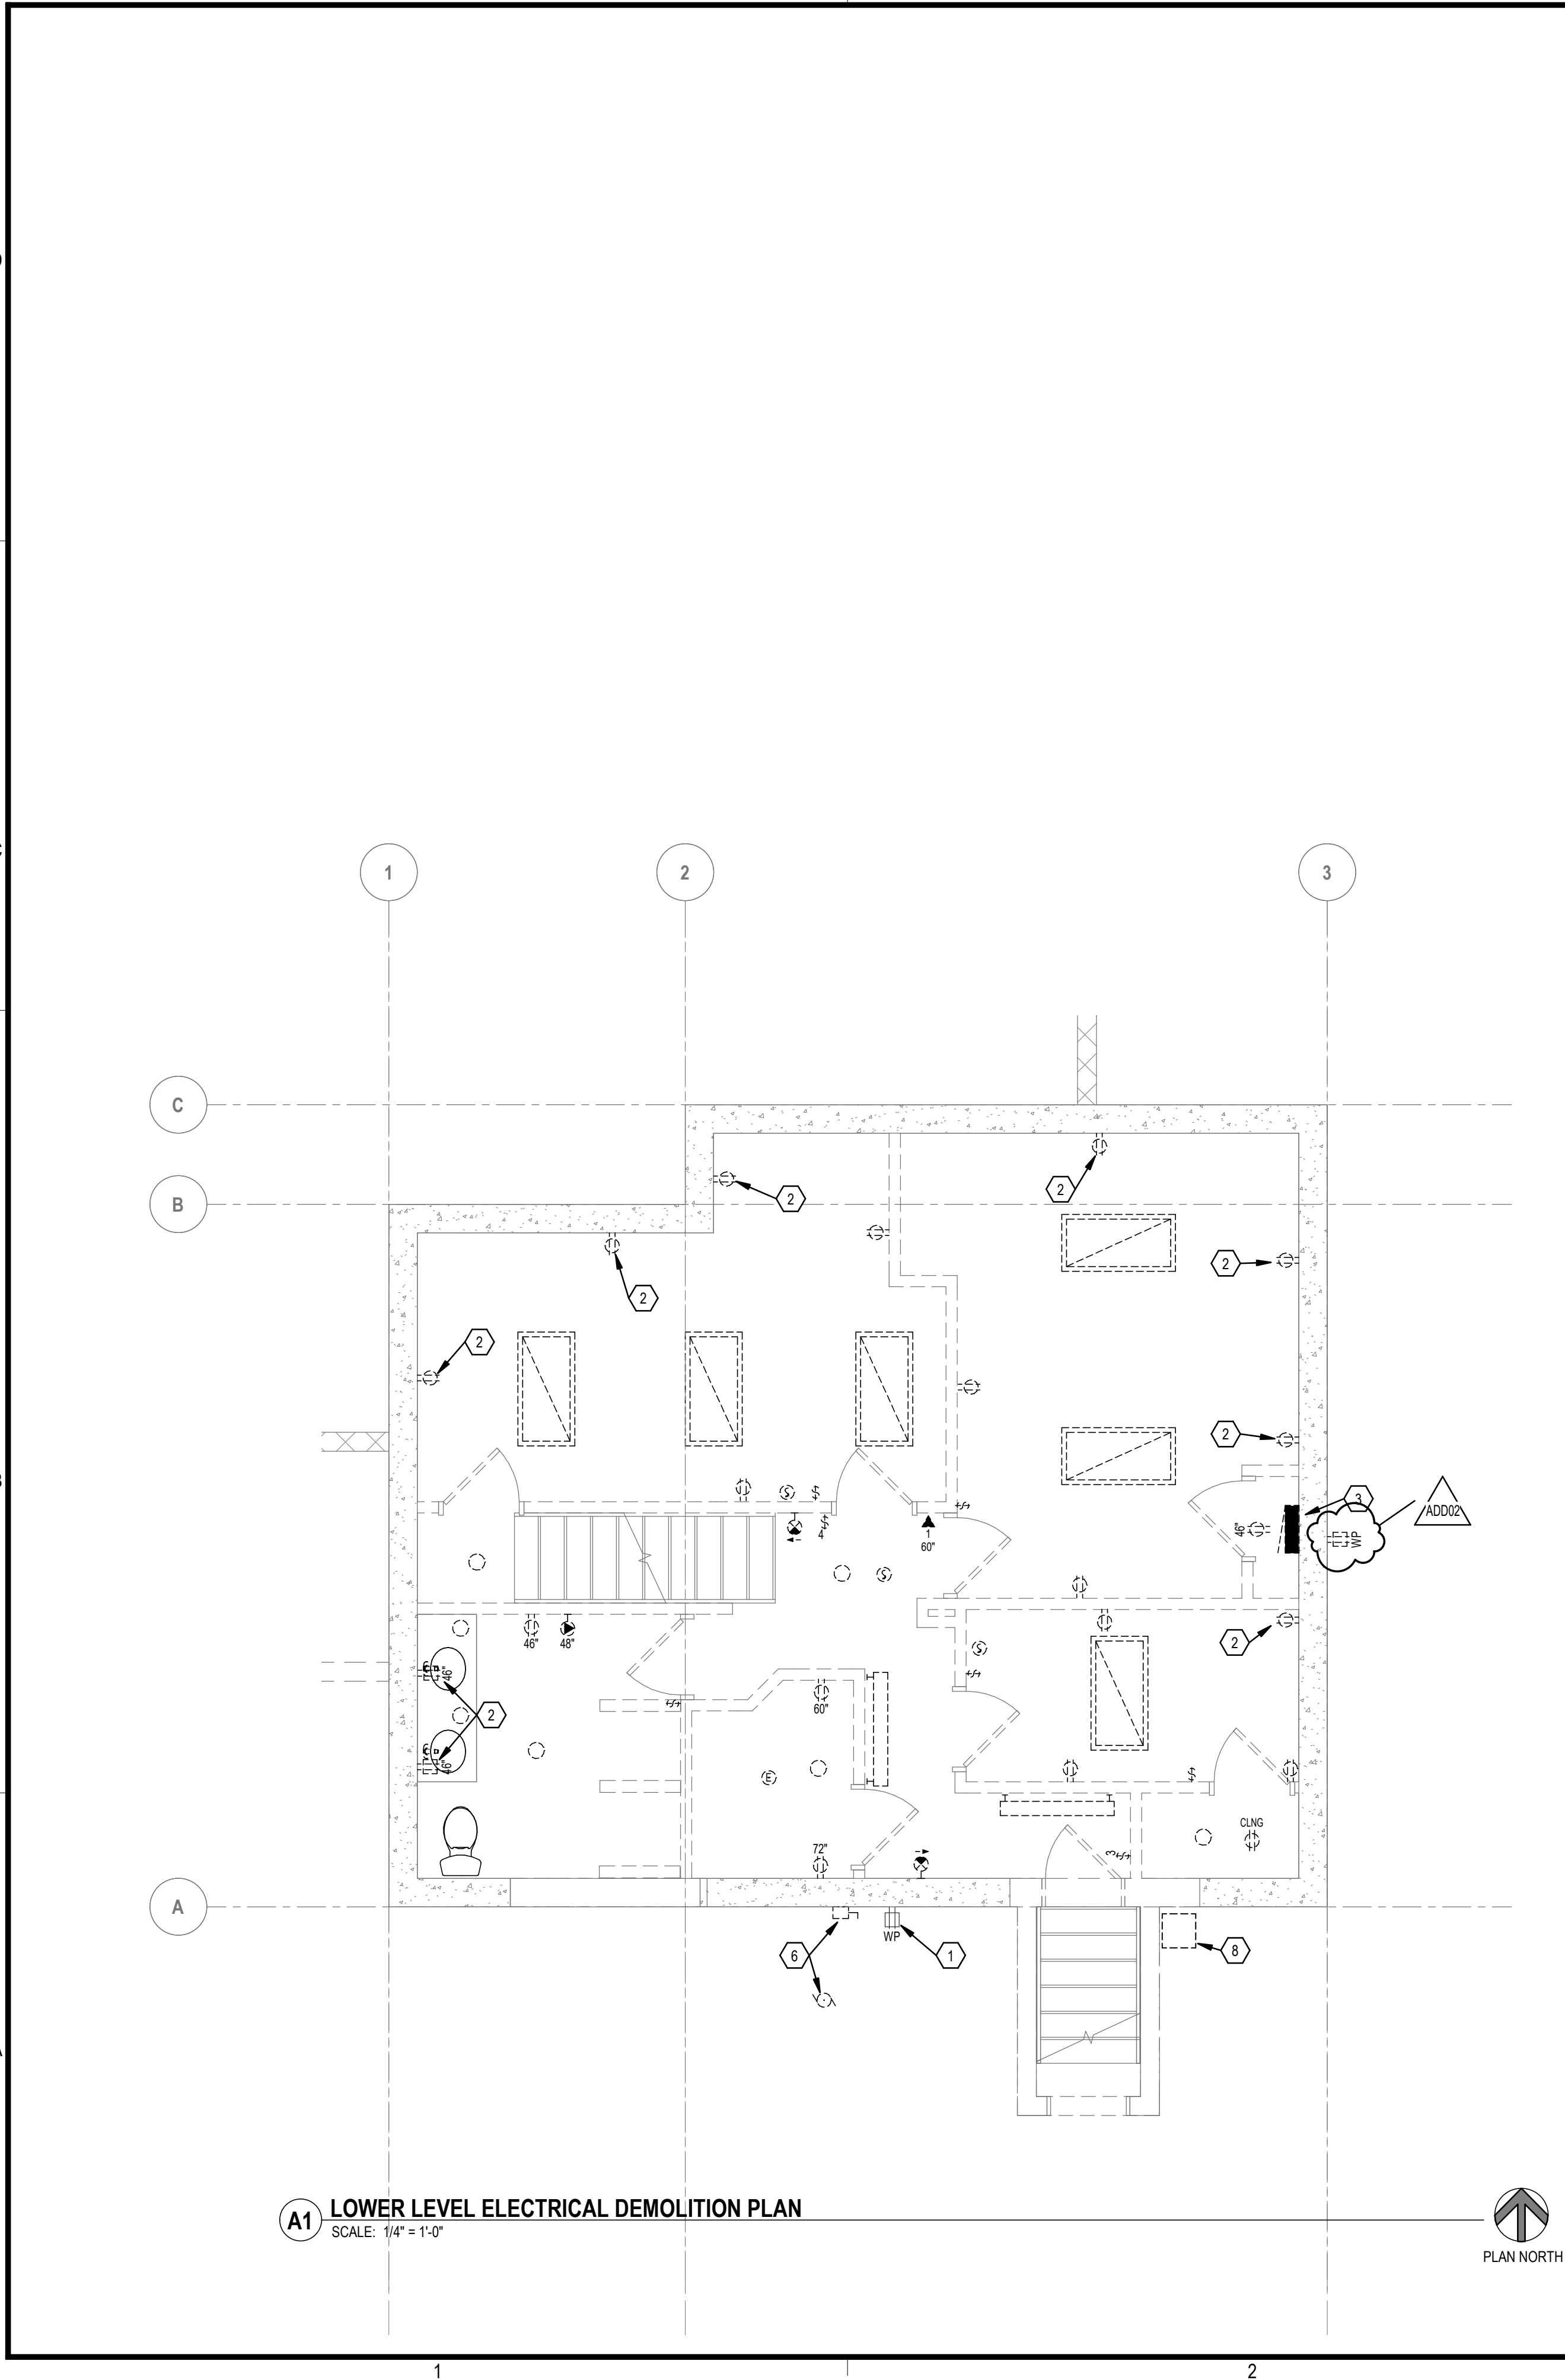

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DATE: 08/31/2023

PROJECT TITLE



**SOUTH DAKOTA
DEPARTMENT OF THE
MILITARY
RENOVATE GENERALS
QUARTERS BUILDING
250**

RC CAMP RAPID

ISSUES

ADD02	09/15/2023	ADDENDUM 2
ISSUE	DATE	DESCRIPTION
ISSUE DATE	08/31/2023	DRAWN BY JJF
PROJECT #	03221580	CHECKED BY KAO

SHEET TITLE

**ELECTRICAL
DEMOLITION PLAN**

SHEET NUMBER

ED101

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KEYNOTES	
1	PROVIDE EXTERIOR HORN/STROBE AT FIRE DEPARTMENT CONNECTION. COORDINATE FINAL MOUNTING LOCATION WITH FIRE SPRINKLER CONTRACTOR.
2	RECESS NEW FIRE ALARM ANNUNCIATOR PANEL INTO EXISTING WALL. COORDINATE CUTTING AND PATCHING OF WALL WITH GC.
3	CUT AND PATCH DRY WALL FOR NEW BOX IN EXISTING WALL. PROVIDE MC CABLE DOWN WALL TO NEW BOX FOR POWER TO NEW RECEPTACLE.
4	PROVIDE 2 1" CONDUITS FROM OLD TELECOM ENTRANCE LOCATION TO NEW TELECOM ENTRANCE LOCATION IN MECHANICAL BUILDINGS ON EACH END OF CONDUIT. ONE CONDUIT FOR TV PROVIDER AND ONE FOR TELECOM PROVIDER. COORDINATE WITH OWNERS TELECOM AND CABLE PROVIDER TO EXTEND SERVICES TO NEW SERVICE ENTRANCE LOCATION.
5	PROVIDE 4 11/16" SQUARE, 2 1/8" DEEP BOX. PROVIDE 1" CONDUIT FROM BOX TO MECHANICAL ROOM. PROVIDE ONE RG-6 CABLE FROM MECHANICAL ROOM TO BOX LOCATION.
6	RECESS FIRE ALARM PULL STATION IN EXISTING WALL. COORDINATE CUTTING AND PATCHING OF WALL WITH GC.
7	ROUTE POWER AND COAX IN HALF WALL FROM BELOW.
8	PROVIDE CONNECTION TO FIRE ALARM TAMPER AND FLOW SWITCHES AS REQUIRED FOR FIRE SPRINKLER SYSTEM. COORDINATE REQUIREMENTS AND QUANTITIES WITH FIRE PROTECTION CONTRACTOR.
9	NEW SERVICE ENTRANCE DISCONNECT. SEE RISER FOR MORE INFORMATION.
10	PROVIDE A NEMA 14-30R RECEPTACLE FOR THE WASHER/DRYER UNIT. COORDINATE RECEPTACLE LOCATION SO THAT CORD IS ACCESSIBLE WHEN UNIT IS INSTALLED.
11	PROVIDE NEW CIRCUIT AS SHOWN TO EXISTING DEVICE.
12	RECEPTACLE FOR ELECTRIC RANGE. COORDINATE RECEPTACLE TYPE WITH RANGE BY OWNER.
13	PROVIDE COMBINATION SMOKE DETECTOR AND CARBON MONOXIDE DETECTOR.
14	PROVIDE SWITCH TO CONTROL EF IN BATHROOM.
15	RECESS FIRE ALARM DEVICE IN EXISTING WALL. COORDINATE CUTTING AND PATCHING OF WALL WITH GC.
16	PROVIDE 120V CIRCUIT TO RANGE HOOD.
17	NEW LOCATION FOR TELECOM BOX. COORDINATE WITH UTILITY FOR EXTEND ANY CABLING AS REQUIRED.
18	NEW RECEPTACLE TO BE MOUNTED WHERE EXTERIOR WALL WAS PATCHED AND FILLED IN.

